PRELIMINARY & FINAL MAJOR SITE PLAN


WHALERS' POINT PROPOSED MULTI-FAMILY BUILDING

2613-2615 ROUTE 88 BOROUGH OF POINT PLEASANT OCEAN COUNTY, NEW JERSEY


BLOCK: 45; LOT: 1; TAX MAP: 7

ZONE: AFFORDABLE HOUSING OVERLAY ZONE



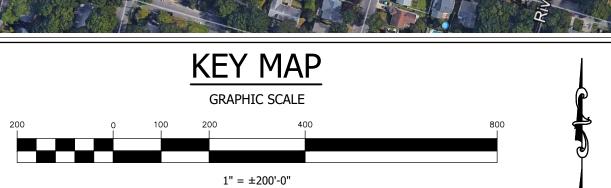

SURROUNDING ZONES BOROUGH OF POINT PLEASANT AFFORDABLE HOUSING OVERLAY ZONE **GENERAL COMMERCIAL** R-1A SINGLE FAMILY

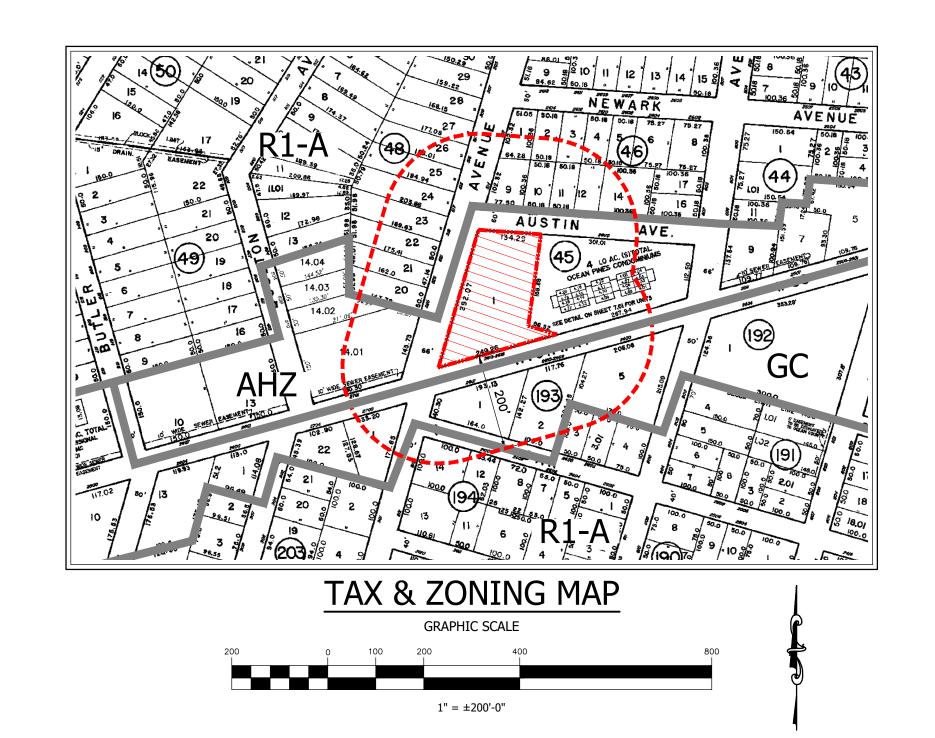

PROPERTY OWNERS WITHIN 200 FEET OF SUBJECT PROPERTY:

BLOCK 45, LOT 4 OCEAN PINES CONDO C/O PINNACLE PROP POINT PLEASANT BEACH, N.

BLOCK 45, LOT 4, C101 KELLY, STEPHANIE 2600 AUSTIN AVE, #101 POINT PLEASANT, NJ 08742 BLOCK 45, LOT 4, C102 DONAHUE, MICHAEL

2600 AUSTIN AVE, #102 POINT PLEASANT, NJ 08742 BLOCK 45, LOT 4, C103 CLARK, BRIAN 2600 AUSTIN AVE, #103 POINT PLEASANT, NJ 08742

BLOCK 45, LOT 4, C104 FRASER, THOMAS 2600 AUSTIN AVE, #104 POINT PLEASANT, NJ 08742 BLOCK 45, LOT 4, C105 MALARON ASSOC. LLC

71 STONY HILL DR

MORGANVILLE, NJ 07751

BLOCK 45, LOT 4, C106 WOJCIK, THOMAS S 1117 RUE AVE POINT PLEASANT, NJ 08742

BLOCK 45, LOT 4, C107 WHITE, CECILIA 2600 AUSTIN AVE, #107 POINT PLEASANT, NJ 08742

BLOCK 45, LOT 4, C108 EDVARDSEN, ELLEN L. 2600 AUSTIN AVE, #108 POINT PLEASANT, NJ 08742

BLOCK 45, LOT 4, C109 KNAPP, ERIC W. 2600 AUSTIN AVE, #109 POINT PLEASANT, NJ 08742 BLOCK 45, LOT 4, C110

O'HARE, THOMAS 2600 AUSTIN AVE, #110 BLOCK 45, LOT 4, C111

POINT PLEASANT, NJ 08742 SOLE, ANDREW PO BOX 331 NEW VERNON, NJ 07976

BLOCK 45, LOT 4, C112 O'BRIEN, TRACEY 2600 AUSTIN AVE, #112

POINT PLEASANT, NJ 08742 BLOCK 45, LOT 4, C113 MEYER, CARIANN 184 OLDFIELD AVE HASBROUCK HEIGHT, NJ 07604

BLOCK 45, LOT 4, C114 2600 AUSTIN AVE 114 LLC 1486 TOWERS ST LAKEWOOD, NJ 08701

BLOCK 45, LOT 4, C115 ROLLIN, SHEILA 2600 AUSTIN AVE, #115 POINT PLEASANT, NJ 08742

BLOCK 45, LOT 4, C116 **HULSE, MICHAEL & FRANK** 2600 AUSTIN AVE, #116 POINT PLEASANT, NJ 08742

PILLAR, MORGAN

2600 AUSTIN AVE, #117

POINT PLEASANT, NJ 08742

BLOCK 46, LOT 2 CYR, RICK 2614 NEWARK AVE POINT PLEASANT, NJ 08742 BLOCK 45, LOT 4, C117 BLOCK 46, LOT 3

SIELSKI, KARI

2600 AUSTIN AVE, #120

BLOCK 46, LOT 1

101 BRIDGE AVE

BAY HEAD, NJ 08742

D'AMATO, MICHAEI

2612 NEWARK AVE

POINT PLEASANT, NJ 08742

POINT PLEASANT, NJ 08742

PARADISE, JAMIE & JOSEPH

BLOCK 45, LOT 4, C118 BLOCK 46, LOT 9 JAIN, ANKUR & RICHA 2600 AUSTIN AVE, #118 514 CURTIS AVE POINT PLEASANT, NJ 08742 POINT PLEASANT, NJ 08742

BLOCK 45, LOT 4, C119 BLOCK 46, LOT 10 EGAN, MACKENZIE HEWITT, TYLER 2600 AUSTIN AVE, #119 2613 NEWARK AVE POINT PLEASANT, NJ 08742 POINT PLEASANT, NJ 08742 BLOCK 45, LOT 4, C120 BLOCK 46, LOT 11 MCELWEE, KIMBERLY CONNOLLY, KIERNAN

> 2612 NEWARK AVE POINT PLEASANT, NJ 08742 BLOCK 46, LOT 12 MERGNER, AMANDA & MATTHEW 2609 NEWARK AVE POINT PLEASANT, NJ 08742

BLOCK 46, LOT 14 DEVERAUX, JOHN J JR 2607 NEWARK AVE POINT PLEASANT, NJ 08742 BLOCK 48, LOT 14.01

COCONUT HOLDINGS LLC

BRADLEY BEACH, NJ 07720

120 MAIN ST

POINT PLEASANT, NJ 08742 BLOCK 48, LOT 23 LEONE, FRANK 519 CURTIS AVE POINT PLEASANT, NJ 08742 BLOCK 48, LOT 24

EVANS, EMIL J & FELIXCA A

POINT PLEASANT, NJ 07036

44 E MUNSELL AVE

BLOCK 48, LOT 14.02

610 BOULTON AVE

BLOCK 48, LOT 20

633 SOUTH AVE

WESTFIELD, NJ 07090

CAPRIO, EDWARD R JR &

POINT PLEASANT, NJ 08742

BLOCK 48, LOT 21

523 CURTIS AVE

BLOCK 48, LOT 22

521 CURTIS AVE

DEGRAW, ANTHONY & RANDI

POINT PLEASANT, NJ 08742

KOZIMBO 2013 IRR TR % J

POINT PLEASANT, NJ 08742 BLOCK 193, LOT 1 LANDAU, ROBERT 406 SLEIGHT AVE STATEN ISLAND, NY 10307

BLOCK 48, LOT 25

515 CURTIS AVE

BLOCK 48, LOT 26

44 E MUNSELL AVE

BLOCK 48, LOT 24

511 CURTIS

CHENEY, ANDREW F & FEENEY,

POINT PLEASANT, NJ 08742

EVANS, EMIL J & FELIXCA A

POINT PLEASANT, NJ 07036

HORNUNG, JOAN EST OF

AULT, HARLEY F & LINDA A BLOCK 193, LOT 2 LITWIN PROPERTIES LLC 1111 HOLLYWOOD BOULEVARD POINT PLEASANT, NJ 08742 BLOCK 193, LOT 3

2605 OAK ST

ARTACHE, MARIANNE

POINT PLEASANT, NJ 08742

BLOCK 193, LOT 5 MAC LINTON LLC 2600 RT 88 POINT PLEASANT, NJ 08742 BLOCK 194, LOT 14 WEAVER, ANTHONY & LISA

810 CURTIS AVE POINT PLEASANT, NJ 08742 BLOCK 203, LOT 1 CML REALTY LLC 2700 LAKEWOOD RD POINT PLEASANT, NJ 08742

1415 WYCKOFF ROAD

WALL, NJ 07719

DEPARTMENT OF PUBLIC WORKS 2233 BRIDGE AVE. POINT PLEASANT, NJ 08742 OCEAN COUNTY PLANNING BOARD 119 HOOPER AVE TOMS RIVER, NJ 08753

175 WEST MAIN STREET

COMCAST CABLEVISION

BOROUGH OF POINT PLEASANT

FREEHOLD, NJ 07728

751 BRICK BLVD.

BRICK, NJ 08723

JERSEY CENTRAL POWER & LIGHT MADISON & PUNCHBOWL RD MORRISTOWN, NJ 07960 NEW JERSEY NATURAL GAS

APPROVED BY THE BOARD OF ADJUSTMENT OF THE BOROUGH OF POINT PLEASANT, COUNTY OF OCEAN, STATE OF NEW JERSEY 4260 US HIGHWAY 1 MONMOUTH JUNCTION NJ 08852 **CHAIRPERSON**

DATE DATE **SECRETARY**

ZONING BOARD APPROVAL

_ BY RESOLUTION #_


BOROUGH ENGINEER

DRAWING No.: DRAWING TITLE: COVER SHEET EXISTING CONDITIONS PLAN **DEMOLITION PLAN** C-04 SITE PLAN C-05 GRADING, DRAINAGE & UTILITY PLAN LANDSCAPING PLAN C-07 LIGHTING PLAN C-08 SOIL EROSION & SEDIMENT CONTROL PLAN C-09 DETAILS - 1 C-10 DETAILS - 2 DETAILS - 3 DETAILS - 4 DETAILS - 5


1103 INDUSTRIAL PARKWAY 732.223.3520 (PHONE

MIDATLANTIC ENGINEERING PARTNERS,

STUDIO 200 ARCHITECTURE, LLC

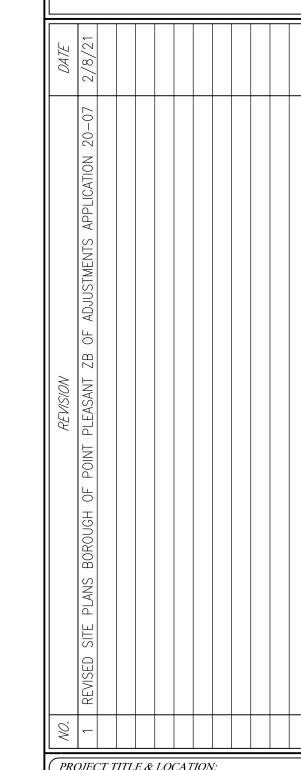

PROJECT TITLE & LOCATION: WHALERS' POINT PROPOSED MULTI-FAMILY BUILDING 2613-2615 ROUTE 88 BOROUGH OF POINT PLEASANT OCEAN COUNTY, NJ BLOCK 45, LOT 1, TAX MAP 7

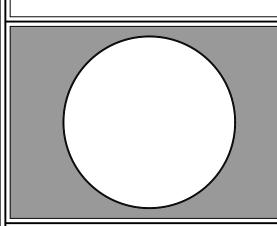

DRAWING TITLE.

DATE

COVER SHEET

REFER TO PLAN 2/8/21 DESIGNED: RPC APPROVED. MED L2A PROJ. No. 2001.223 DRAWING No..



REFERENCES:

THIS PROJECT REFERENCES A SURVEY PREPARED BY: MIDATLANTIC ENGINEERING PARTNERS, LLC

GATEWAY 195 CENTRE, 5 COMMERCE WAY, SUITE 200, HAMILTON, NJ 08691 DATED: 01/03/2019 PROJECT NO.: CGC-182

609.910.4450 (OFFICE)

GENERAL NOTES


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- 2. ALL WORK SHALL BE PERFORMED IN ACCORDANCE WITH THESE PLANS AND SPECIFICATIONS AND THE REQUIREMENTS AND STANDARDS OF THE LOCAL GOVERNING AUTHORITY.

3. THE PROPERTY SURVEY IS CONSIDERED A PART OF THESE PLANS.

- 4. ALL DIMENSIONS SHOWN ON THE PLANS SHALL BE FIELD VERIFIED BY THE CONTRACTOR PRIOR TO CONSTRUCTION. THE CONTRACTOR SHALL NOTIFY THE ENGINEER IF ANY DISCREPANCIES EXIST PRIOR TO PROCEEDING WITH CONSTRUCTION FOR NECESSARY PLAN CHANGES. NO EXTRA COMPENSATION SHALL BE PAID TO THE CONTRACTOR FOR WORK HAVING TO BE REDONE DUE TO DIMENSIONS OR GRADES SHOWN INCORRECTLY ON THESE PLANS IF SUCH NOTIFICATION HAS NOT BEEN GIVEN.
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- 8. THE PROPERTY CORNERS MUST BE STAKED PRIOR TO THE COMMENCEMENT OF CONSTRUCTION ACTIVITIES.
- 9. THE CONTRACTOR SHALL BE RESPONSIBLE FOR THE PROTECTION OF ALL ITEMS AND FEATURES WHICH ARE TO REMAIN WHETHER SHOWN ON THE DRAWINGS OR NOT.
- 10. THE CONTRACTOR SHALL PROVIDE ALL NECESSARY SAFEGUARDS INCLUDING THE INSTALLATION OF SHORING, STRUCTURAL SUPPORTS, PROTECTIVE FENCING AND BARRIERS, ETC., AS MAY BE REQUIRED TO PREVENT UNAUTHORIZED
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- 14. THE CONTRACTOR SHALL CLEAN UP AND REMOVE ALL REFUSE RUBBISH, SCRAP MATERIALS, UNSUITABLE MATERIALS AND DEBRIS CAUSED BY HIS/HER OPERATIONS SO THAT, AT ALL TIMES, THE SITE OF THE WORK SHALL PRESENT A NEAT, ORDERLY AND WORKMANLIKE APPEARANCE.
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- 16. ALL SIDEWALKS AND BARRIER-FREE ACCESSIBLE ROUTES SHALL BE CONSTRUCTED IN STRICT CONFORMANCE WITH CURRENT ADA DESIGN STANDARDS.

LEGEND

	<u>LLGLIID</u>
	EXISTING BUILDING
=====	EXISTING STORM LINE
G	EXISTING GAS LINE
OH	EXISTING OVERHEAD ELECTRIC
w	EXISTING WATER LINE
\	EXISTING CONTOUR
X 15.00	EXISTING SPOT ELEVATION
	PROPERTY LINE
	ADJACENT PROPERTY LINE

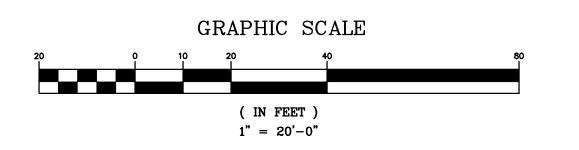



60 GRAND AVENUE ENGLEWOOD, NJ 07631 201.227.0300 • 201.227.0001 (Fax) www.L2Alanddesign.com New Jersey Certificate of Authorization No. 24GA28130900

Michael E. Dipple, P.E.

New Jersey Professional Engineer #24GE04081200

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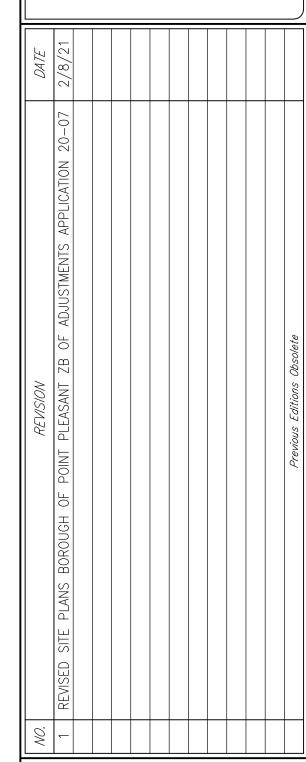
OWNER/APPLICANT: R2T2, LLC 1103 INDUSTRIAL PARKWAY

BRICK, NJ 08724 732.223.3520 (PHONE)


SURVEYOR:

MIDATLANTIC ENGINEERING PARTNERS, LLC GATEWAY 195 CENTRE 5 COMMERCE WAY, SUITE 200 HAMILTON, NJ 08691 609.910.4450 (PHONE)

ARCHITECT: STUDIO 200 ARCHITECTURE, LLC. 200 UNION AVENUE BRIELLE, NJ 08730 732.528.2240 (PHONE)




PROJECT TITLE & LOCATION: WHALERS' POINT PROPOSED MULTI-FAMILY BUILDING 2613-2615 ROUTE 88 BOROUGH OF POINT PLEASANT OCEAN COUNTY, NJ BLOCK 45, LOT 1, TAX MAP 7

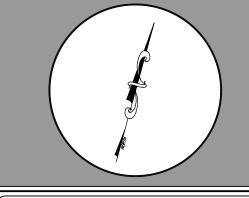

DRAWING TITLE:

EXISTING CONDITIONS PLAN

REFER TO PLAN 2/8/21 DESIGNED: RPC APPROVED: MED L2A PROJ. No.. 2001.223 DRAWING No.:

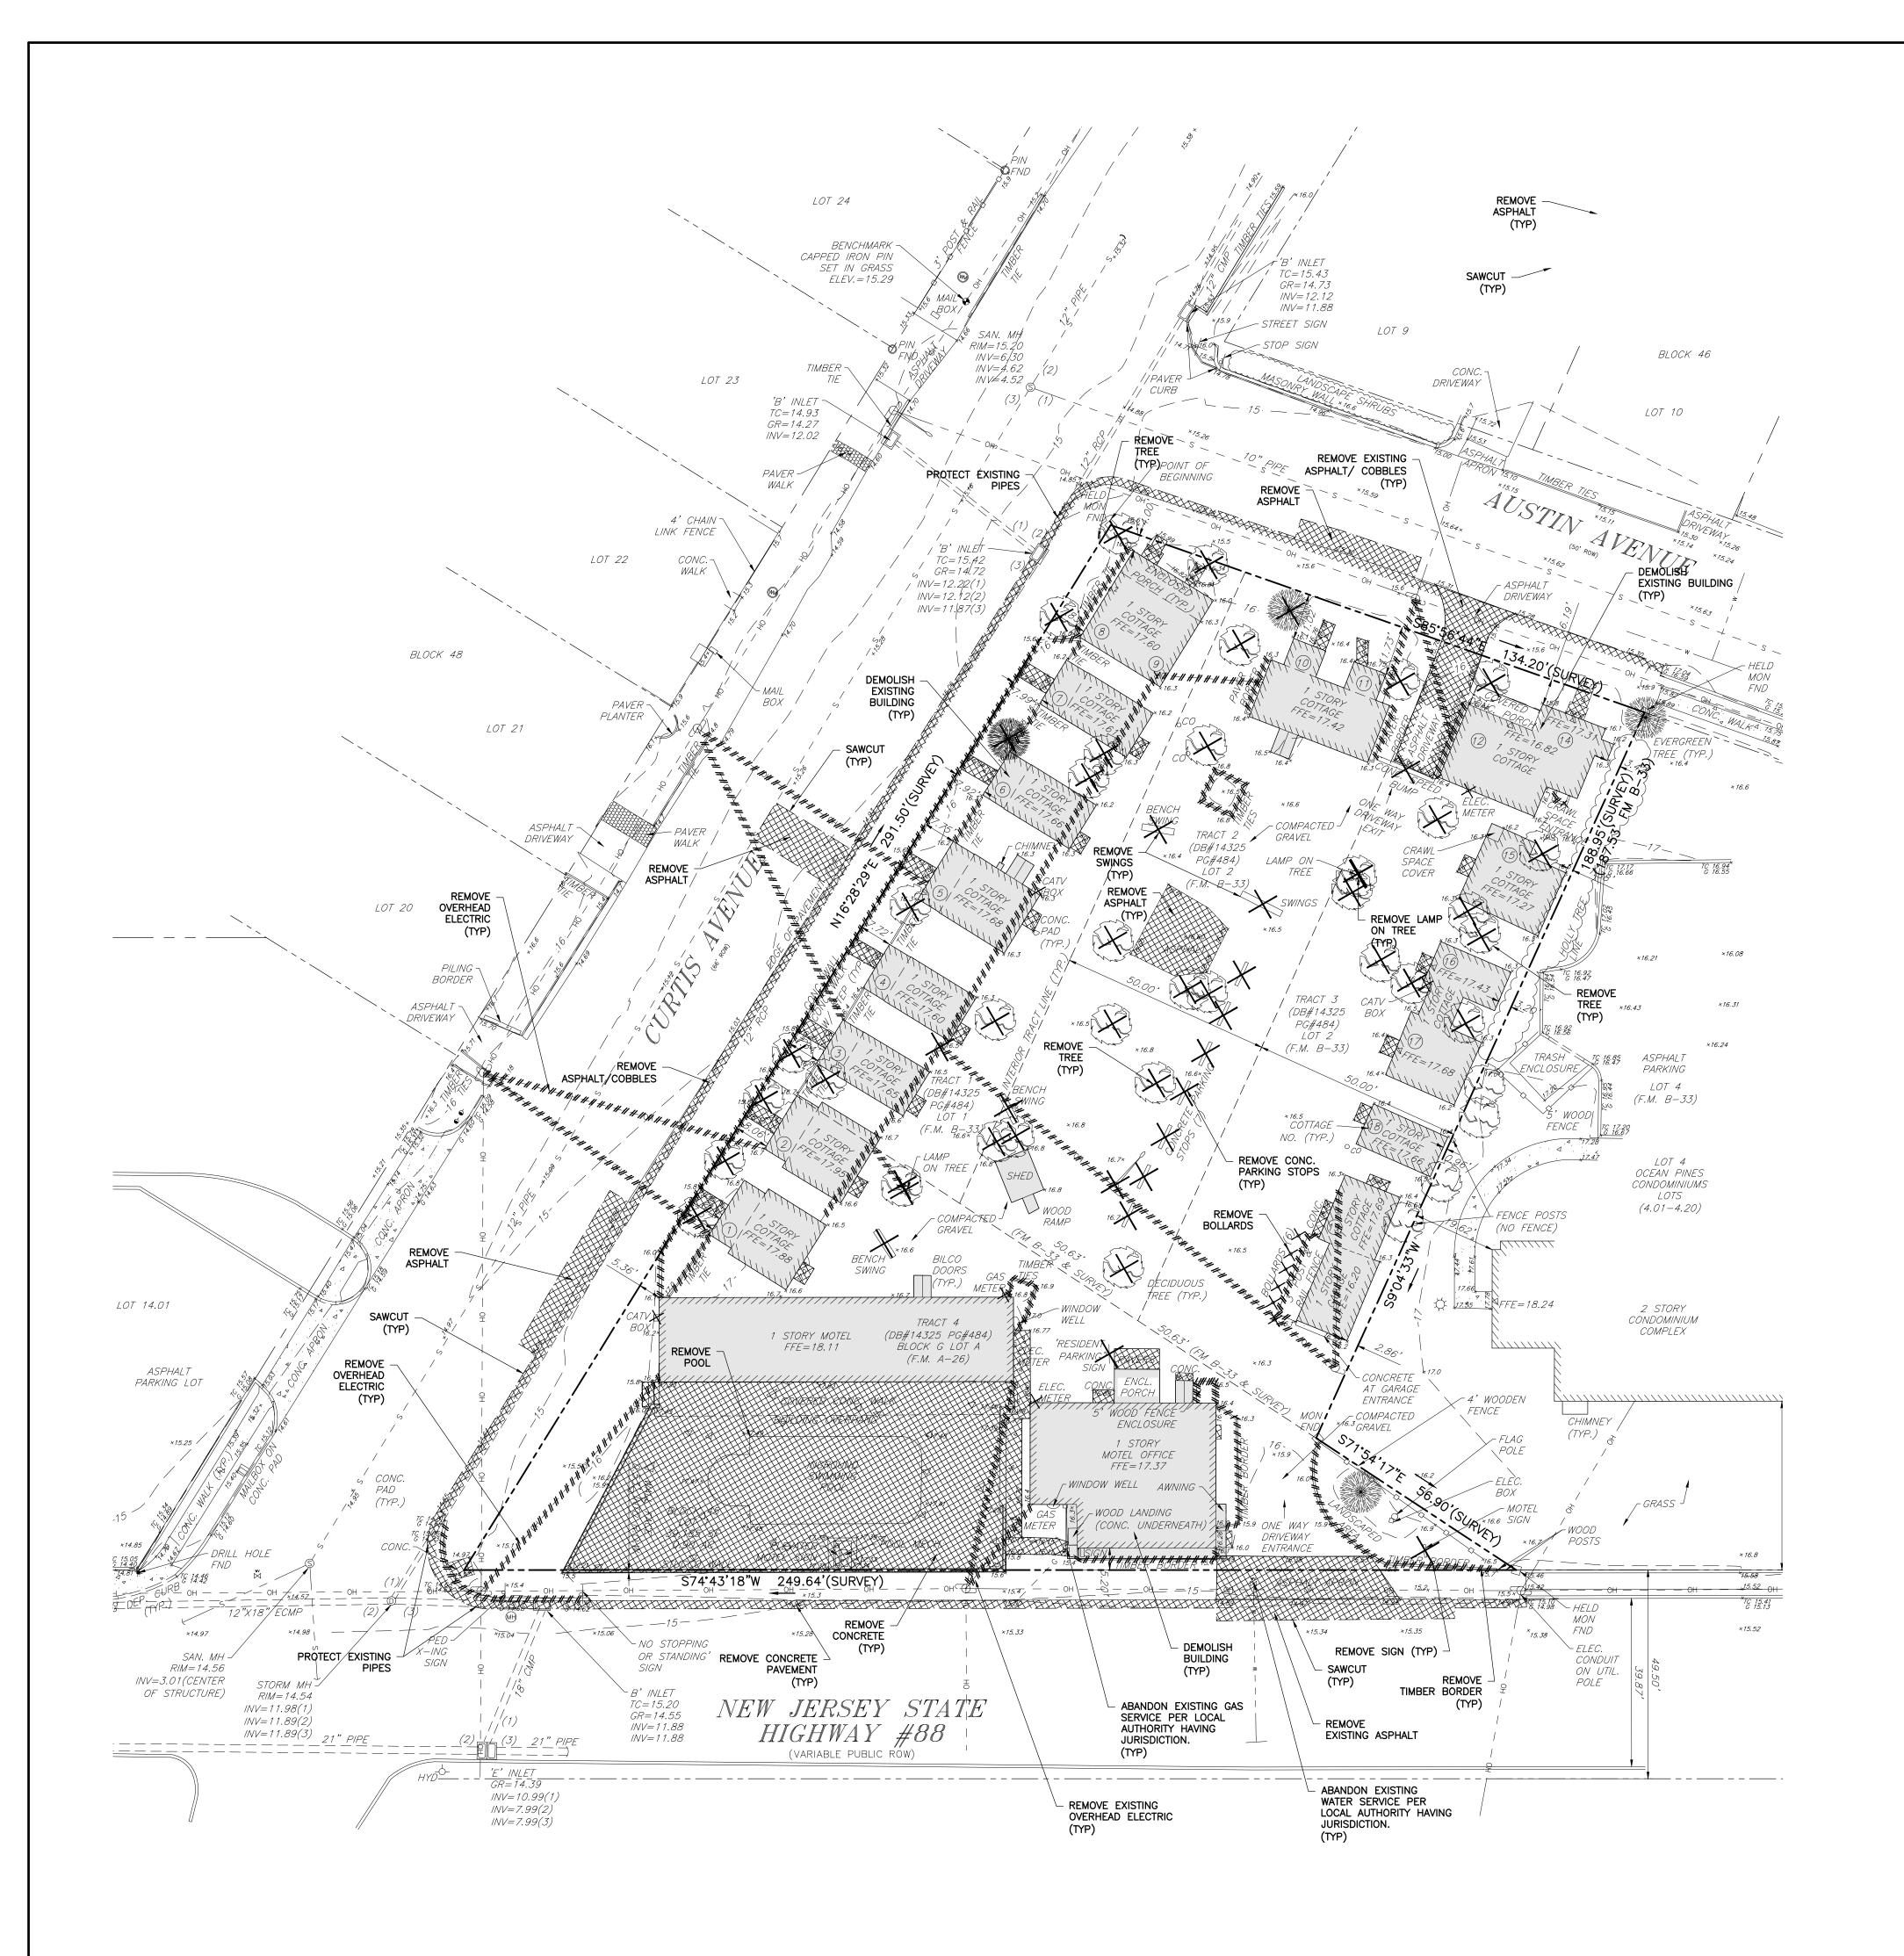

DEMOLITION AND REMOVAL NOTES

- 1. CONTRACTOR SHALL PROTECT ALL UTILITIES AND SITE FEATURES THAT ARE SCHEDULED TO REMAIN.
- 2. ALL DEMOLITION ACTIVITIES ARE TO BE PERFORMED IN STRICT ADHERENCE TO ALL FEDERAL, STATE, AND LOCAL REGULATIONS.
- 3. WHEREVER ASPHALT OR CONCRETE PAVEMENT IS REMOVED, THE CONTRACTOR SHALL SAW-CUT AND NEATLY TRIM THE EDGE OF REMAINING PAVEMENTS BEFORE INSTALLING NEW CONSTRUCTION. ASPHALT PAVEMENT SHALL BE REMOVED TO THE SUBGRADE.
- 4. WHERE REMOVAL OF CONCRETE CURB IS SHOWN ON THE CONTRACT DRAWINGS, THE REMOVAL LIMITS SHALL BE TO THE NEAREST CURB JOINTS.
- 5. DEMOLITION USING EXPLOSIVE, INCENDIARY, OR WRECKING BALL METHODS IS PROHIBITED.
- 6. CONDUCT DEMOLITION/REMOVAL OPERATIONS AND DISPOSAL OF DEBRIS TO ENSURE MINIMUM INTERFERENCE WITH THE USE OF, OR ACCESS TO, ADJACENT BUILDINGS OR CONSTRUCTION SITE AREA. DO NOT UNNECESSARILY OBSTRUCT SIDEWALKS OR STREETS.
- 7. PROVIDE TEMPORARY INTERIOR SHORING, BRACING AND/OR SUPPORT AS REQUIRED ENSURING THAT MOVEMENT OR
- SETTLEMENT OF STRUCTURES TO BE DEMOLISHED IS SAFELY CONTROLLED AND COLLAPSE IS PREVENTED.

 8. USE WATER SPRINKLING, ENCLOSED CHUTES, AND/OR TEMPORARY ENCLOSURES TO LIMIT DUST AND DIRT RISING AND SCATTERING IN THE AIR. PROVIDE A WATER TRUCK, WATER LINE, AND HOSES FOR THIS PURPOSE. DO NOT USE WATER
- 9. DO NOT DISTURB SERVICE TO OFF-SITE FIRE HYDRANTS IN ANY WAY WITHOUT WRITTEN APPROVAL OF THE ENGINEER. IF, WITH WRITTEN APPROVAL OF THE ENGINEER, WATER SERVICE TO ANY AREA IS DISRUPTED, MAKE PROVISIONS TO ENSURE ADEQUATE FIRE PROTECTION FOR SUCH AREA.

WHEN IT MAY CREATE HAZARDOUS OR OBJECTIONABLE CONDITIONS SUCH AS ICING OR FLOODING.

- 10. AT ALL TIMES, MAINTAIN ACCESSIBILITY FROM THE STREET TO ALL FIRE HYDRANTS, TRAFFIC SIGNALS, POWER OR LIGHT
- POLES, MAILBOXES, AND SIMILAR UTILITY AND PUBLIC SERVICE ITEMS ADJACENT TO THE CONSTRUCTION SITE.


 11. DO NOT INTERRUPT UTILITIES SERVING OCCUPIED OR USED AREAS, EXCEPT WHEN AUTHORIZED BY THE ENGINEER.
- PROVIDE TEMPORARY SERVICES DURING SUCH INTERRUPTIONS AS APPROVED BY THE ENGINEER.

 12. DO NOT STORE ANY MATERIALS, RUBBISH, DIRT, DEBRIS, OR WASTE OF ANY SORT RESULTING FROM THE DEMOLITION
- OPERATIONS ON THE FLOOR OF PARTIALLY DEMOLISHED STRUCTURES OR ADJACENT CONSTRUCTION SITE AREAS.

 13. DISPOSE DEBRIS, RUBBISH, AND OTHER MATERIALS RESULTING FROM DEMOLITION OPERATIONS AWAY FROM THE
- CONSTRUCTION SITE.
- 14. DO NOT BURN, BURY, OR OTHERWISE DISPOSE OF DEBRIS, RUBBISH, OR OTHER MATERIALS RESULTING FROM DEMOLITION OPERATIONS.
- 15. STORAGE OR SALE OF ITEMS OF SALVABLE VALUE TO THE CONTRACTOR IS PROHIBITED AT THE CONSTRUCTION SITE.

LEGEND

	LLOLIND
	EXISTING BUILDING
======	EXISTING STORM LINE
G	EXISTING GAS LINE
— — ОН— — —	EXISTING OVERHEAD ELECTRIC
w	EXISTING WATER LINE
\15	EXISTING CONTOUR
X 15.00	EXISTING SPOT ELEVATION
	REMOVE ASPHALT/CONCRETE
	DEMOLISH BUILDING
· // // // //	REMOVE/DEMOLISH LINEAR ITEM
×	REMOVE INDIVIDUAL ITEM
	SAWCUT LINE
	PROPERTY LINE
	ADJACENT PROPERTY LINE

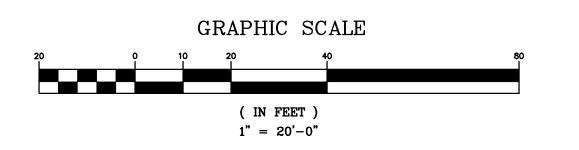



60 GRAND AVENUE
ENGLEWOOD. NJ 07631
201.227.0300 • 201.227.0001 (Fax)
www.L2Alanddesign.com
New Jersey Certificate of Authorization No. 24GA28130900

That Of

Michael E. Dipple, P.E.

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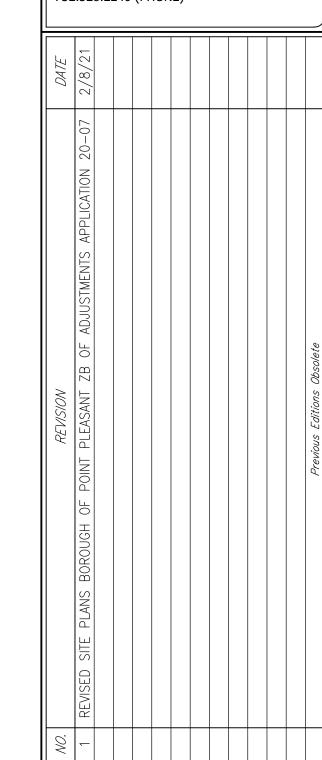
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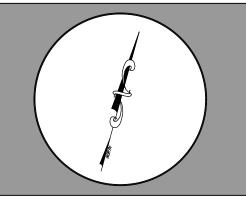
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ARCHITECT:
STUDIO 200 ARCHITECTURE, LLC.
200 UNION AVENUE
BRIELLE, NJ 08730
732.528.2240 (PHONE)



PROJECT TITLE & LOCATION:
WHALERS' POINT
PROPOSED MULTI-FAMILY BUILDING
2613-2615 ROUTE 88
BOROUGH OF POINT PLEASANT
OCEAN COUNTY, NJ
BLOCK 45, LOT 1, TAX MAP 7



DRAWING TITLE:

DEMOLITION PLAN

SCALE: REFER TO PLAN

DATE 2/8/21

DESIGNED: RPC

APPROVED: MED

L2A PROJ. No.: 2001.223

DRAWING No.:

C-03

GENERAL NOTES

LOT 14.01

ASPHALT

PARKING LOT

- PRIOR TO STARTING CONSTRUCTION, THE CONTRACTOR SHALL BE RESPONSIBLE TO MAKE SURE THAT ALL REQUIRED PERMITS AND APPROVALS HAVE BEEN OBTAINED. NO CONSTRUCTION OR FABRICATION SHALL BEGIN UNTIL THE CONTRACTOR HAS RECEIVED AND THOROUGHLY REVIEWED ALL PLANS AND OTHER DOCUMENTS BY ALL OF THE PERMITTING AUTHORITIES
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LOT 24

BENCHMARK

RETAINING

STAIRS

(TYP)

50' FRONT

YARD SETBACK

S74.43.18.W 249.64.(SURVEY) 4 4 WIDE CONC. SIDEWALK (TYP)

4" NJDOT CONCRETE

CURB & NJDOT FULL

PAVEMENT REPAIR (TYP)

(SEE ARCHITECTURAL NEW JERSEY STATE

6" CONCRETE

CURB (TYP)

SAWCUT & FULL

PAVEMENT REPAIR

DEPTH ASPHALT

PAVFR ~

COVERED

CONCRETE

39,185 SF

~ NO STOPPING

MONUMENT SIGN

OR STANDING'

CURB

ENTRY WAY

WALL MOUNTED -

LIGHT (TYP)

PLANTER

LOT 21

AASHTO 16'x335' SIGHT TRIANGLE

30 MPH DESIGN)

(25 MPH SPEED LIMIT,

PILING BORDER

ASPHALT

DRIVEWAY

PEDESTRIAN

CROSSWALK

DETECTABLE WARNING

AASHTO 16'x290' -SIGHT TRIANGLE

30 MPH DESIGN)

(25 MPH SPEED LIMIT,

END NJDOT 4" $^{\circ}$ CURB AND START

> 6" CONCRETE CURB (TYP)

> > ADA RAMP &

SURFACE (TYP)

DETECTABLE WARNING

SURFACE (TYP)

ASPHALT -DRIVEWAY

WALL

- STREET SIGN

AASHTO 14.5'x290'

(25 MPH SPEED LIMIT,

SIGHT TRIANGLE

30 MPH DESIGN)

COVERED GARAGE WITH APARTMENT UNITS

R=10'

ADA RAMP & DETECTABLE WARNING

SURFACE (TYP)

BEGINNING

APARTMENT BUILDING 1ST FL. - 4 UNITS

2ND FL. — 10 UNITS

3RD FL. - 10 UNITS

6" CONCRETE

CURB (TYP)

DIRECTIONAL

POLE MOUNTED -

LIGHT (TYP)

ARROWS (TYP)

- R=2'

DIRECTIONAL

SIGN (TYP)

LOT 9

DRIVEWAY

- 6" CONCRETE

CURB (TYP)

MEET EXISTING

CONCRETE CURB

FENCE

(NO FENCE)

-4' WOODEN

FENCE

TRASH ENCLOSURE

WITH PEDESTRIAN

SIDE ENTRY

51.36

(DEPRESSED CURB)

DEPRESSED

& SIDEWALK FLUSH

CAPPED IRON PIN SET IN GRASS ELEV.=15.29

- SOLID WASTE TO BE DISPOSED OF BY THE CONTRACTOR IN ACCORDANCE WITH ALL LOCAL, STATE AND
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- 15. THE CONTRACTOR SHALL, AT HIS/HER OWN EXPENSE, REPAIR OR REPLACE ALL GROUND SURFACES, PAVEMENTS, SIDEWALKS, CURBS, ETC., WHICH ARE TO REMAIN AND WHICH MAY BECOME DISTURBED OR DAMAGED DUE TO HIS/HER OPERATION.
- 16. ALL SIDEWALKS AND BARRIER-FREE ACCESSIBLE ROUTES SHALL BE CONSTRUCTED IN STRICT CONFORMANCE WITH CURRENT ADA DESIGN STANDARDS.

PROJECT NOTES:

BLOCK 46

AASHTO 14.5'x335' SIGHT TRIANGLE

30 MPH DESIGN)

(25 MPH SPEED LIMIT,

PARKING

LOT 4

(F.M. B-33)

OCEAN PINES CONDOMINIUMS

(4.01-4.20)

2 STORY

COMPLEX

CONDOMINIUM

MEET EXISTING

CONCRETE CURB & SIDEWALK

- THIS PROJECT REFERENCES A SURVEY PREPARED BY:
- MIDATLANTIC ENGINEERING PARTNERS, LLC GATEWAY 195 CENTRE, 5 COMMERCE WAY, SUITE 200, HAMILTON, NJ 08691
- DATED: 01/03/2019 PROJECT NO.: CGC-182
- 609.910.4450 (OFFICE) PROPERTY LOCATION: BLOCK 45, LOT 1
- PROPERTY ADDRESS: 2613-2615 NJ STATE HIGHWAY 88, BOROUGH OF POINT PLEASANT, NJ 08742
- ZONE: AFFORDABLE HOUSING OVERLAY ZONE
- EXISTING USE: MOTEL PROPOSED USE: 24-UNIT APARTMENT BUILDING (PERMITTED)
- LOT AREA: 39,185 SF (±0.90 AC.)

ZONE: AFFORDABLE HOUSING OVERLAY ZONE [§19-15.C.7]	PERMITTED	EXISTING	PROPOSED	VARIANCE REQUIRED
MINIMUM LOT AREA (AC)	0.80 AC	0.90 AC	0.90 AC	NO
MINIMUM LOT WIDTH (FT)	150 FT	154 FT	154 FT	NO
MINIMUM LOT FRONTAGE (HWY# 88) (FT)	150 FT	249.64 FT	249.64 FT	NO
FRONT YARD SETBACK [ROUTE 88] (FT) 1,2	50 FT ²	5.20 FT	50.00 FT	NO
SIDE YARD SETBACK [CURTIS AVE.] (FT) 1,2	15 FT ²	5.36 FT	15.00 FT	NO
SIDE YARD SETBACK [LOT 4] (FT) 1,2	30 FT	0.96 FT	41.56 FT	NO
REAR YARD SETBACK [AUSTIN AVE.] (FT) 1,2	30 FT	4.00 FT	8.24 FT	YES
MAXIMUM LOT COVERAGE (%)	70%	82.40%	66.13%	NO
MAXIMUM BUILDING HEIGHT (STORIES/FT) 3	3 STORIES/42 FT	<35 FT	3 STORIES/41.46 FT	NO
MAXIMUM UNITS PER ACRE	8 UNITS/ACRE	N/A	26.7 UNITS/ACRE	YES

- §19-3 CORNER LOT: SHALL MEAN A PARCEL OF LAND AT THE INTERSECTION OF AND FRONTING ON TWO (2) OR MORE STREETS
- 2. §19-5(C)(1)(B): IN THE CASE OF CORNER LOTS, THE SETBACK LINE OF ONE (1) PORTION OF THE BUILDING MUST CONFORM TO THE FRONT SETBACK LINE OF ONE (1) OF THE ADJACENT STREETS, AND THE OTHER SIDE OF THE BUILDING ADJACENT TO THE OTHER STREET MUST BE FIFTEEN (15') FEET FROM THE PROPERTY LINE. THE NARROWEST DIMENSION OF THE LOT ON A STREET SHALL BE CONSIDERED THE FRONT OF THE LOT PROVIDED, HOWEVER, ON MAJOR STREETS, THAT PORTION FRONTING ON A MAJOR STREET SHALL BE CONSIDERED THE FRONT OF THE LOT. [MAJOR STREET - ROUTE 88]
- 3. §19-3 BUILDING HEIGHT: THE VERTICAL DIMENSIONS MEASURED FROM THE CROWN OF THE NEAREST IMPROVED STREET ON WHICH THE BUILDING OR STRUCTURE IS LOCATED TO THE HORIZONTAL PLANE OF THE HIGHEST POINT OF THE ROOF OF THE STRUCTURE OR BUILDING. THE POINT IN THE CROWN OF THE STREET FROM WHICH THE MEASUREMENT IS TAKEN SHALL BE THE MIDPOINT BETWEEN THE EXTENSION OF THE SIDE LINES OF THE LOT WHICH INTERSECT THE CROWN OF SAID IMPROVED STREETS. THE HEIGHT LIMITATIONS OF THIS CHAPTER SHALL NOT APPLY TO CHURCH SPIRES, NONCOMMERCIAL ANTENNAS, BELFRIES, CUPOLAS, CHIMNEYS, VENTILATORS, SKYLIGHTS PROVIDED THAT NO FIRE HAZARD IS CREATED AND PROVIDED THAT SUCH EXEMPTION COVERS NOT MORE THAN 10% OF THE ROOF AREA AND NO GREATER THAN 10 FEET ABOVE THE PERMITTED HEIGHT. FOR PROPERTIES WITHIN THE AREA INUNDATED BY THE 100-YEAR FLOOD, THE BUILDING HEIGHT IS MEASURED FROM THE BASE FLOOD PLAIN ELEVATION LEVEL INSTEAD OF THE CROWN OF THE STREET. PARAPETS SHALL ALSO NOT BE INCLUDED IN THE HEIGHT CALCULATION AS LONG AS THEY USED TO SHIELD MECHANICAL EQUIPMENT AND DO NOT EXCEED FOUR FEET ABOVE THE BASELINE ROOF ELEVATION. THE DEFINITION OF BUILDING HEIGHT IS FURTHER AMENDED TO INCLUDE GUIDANCE ON CORNER LOTS; IN PARTICULAR, THE CROWN SHALL BE CONSIDERED FROM THE STREET OF THE HIGHEST ELEVATION.
 - ELEVATION OF CROWN OF ROAD BETWEEN SIDE LINES PERPENDICULAR TO AUSTIN AVENUE = 15.62'
 - MAXIMUM ALLOWABLE ELEVATION OF HIGHEST BUILDING PEAK = 15.62' + 42.00' = 57.62'
 - PROPOSED HEIGHT OF BUILDING FROM GRADE TO HIGHEST PEAK OF BUILDING = 40.08' PROPOSED FIRST FLOOR ELEVATION = 16.75'

 - ELEVATION OF HIGHEST PEAK FROM FINISHED FLOOR ELEVATION = 17.00' + 40.08' = 57.08'
 - BUILDING HEIGHT CALCULATION = 57.08'-15.62' = 41.46' (COMPLIES)

PARKING REQUIREMENTS

PARKING ORDINANCE PER RSIS	REQUIRED	PROPOSED	VARIANCE REQUIRED
GARDEN APARTMENTS: 1-BR UNIT: 1.8 SPACES/UNIT	(4) 1-BR UNITS 4 UNIT X 1.8 SPACES = 7.2 SPACES		
2-BR (OR MORE): 2 SPACES/UNIT	(20) 2-BR UNITS 20 UNIT X 2.0 SPACES = 40 SPACES	47 SPACES	NO
TOTAL REQUIRED PARKING 1	7.2 SPACES + 40 SPACES = 47.2 SPACES = 47 SPACES		

- PER NJAC 5:21-4.14 (RSIS): WHEN A DETERMINATION OF THE REQUIRED NUMBER OF PARKING SPACES RESULTS IN A FRACTIONAL SPACE FOR THE ENTIRE DEVELOPMENT, ANY FRACTION OF ONE-HALF OR LESS MAY BE DISREGARDED, WHILE A FRACTION IN EXCESS OF ONE-HALF SHALL BE COUNTED AS ONE
- 2. §19-28.4(b)(2): SIZE OF PARKING STALLS SHALL BE 10' X 20' (PROPOSED = 9' X 18') [DESIGN WAIVER]
- 3. §19-28.5(p): TWO WAY OPERATION DRIVEWAY WIDTH FOR 10 OR MORE DWELLING UNITS SHALL BE 30-36 FT WIDE (PROPOSED = 24 FT) [DESIGN
- 4. §19-28.5(c): MINIMUM DISTANCE OF PARKING TO PROPERTY LINE SHALL BE 5 FEET (PROPOSED = 3.50 FT) [DESIGN WAIVER]
- §19-28.5(c): NO PARKING WITHIN FRONT YARD SETBACK [DESIGN WAIVER]
- 6. §19-28.5(a): NO PARKING PERMITTED WITHIN 25 FT. OF AN INTERSECTION (PARKING AND CURTIS AVE = 15.56') [DESIGN WAIVER]

SIGNAGE REQUIREMENTS

SIGN ORDINANCE [§9-8 SIGNS]	PERMITTED		PROPOSED	WAIVER REQUIRED	
MONUMENT SIGN	MAXIMUM AREA = BOTTOM HEIGHT= PROPERTY LINE SETBACK =	20 SF ¹ 8 FT ² 5 FT ³	MAXIMUM AREA = BOTTOM HEIGHT= PROPERTY LINE SETBACK =	20.00 SF 2.00 FT 6.18 FT	NO YES NO


- §9-12(e): A SIGN SHALL BE PERMITTED ON THE FRONT OF ANY BUILDING PROVIDING SAID SIGN DOES NOT EXCEED A TOTAL AREA OF TWENTY (20) SQUARE FEET AND THAT THE SUM TOTAL OF THE AREA OF ALL THE SIGNS ON SAID PREMISES INCLUDING ANY SIGN ON THE FRONT OF A BUILDING SHALL NOT EXCEED TWENTY (20) SQUARE FEET [COMPLIES].
- §9-8(a)8: NO SIGN MAY BE LOCATED CLOSER THAN FIVE (5') FEET TO ANY PROPERTY LINE ADJACENT TO A STREET OR CORNER UPON WHICH SUCH SIGN IS

§9-8(a)10: THE BOTTOM OF NO SIGN SHALL BE LOWER THAN EIGHT (8') FEET UNLESS THAT SIGN IS SET BACK AT LEAST TEN (10') FEET [DESIGN

4. §9-13(a): FOR THE PURPOSES OF MEASURING FOOTAGE, DOUBLE-SIDED SIGNS SHALL BE MEASURED AS IF ONE-SIDED.

LEGEND

	LLOLIND
	PROPOSED BUILDING
	PROPOSED CONCRETE AREA
	PROPOSED CURB
	PROPOSED DEPRESSED CURB
	PROPOSED RETAINING WALL
Û	PROPOSED DIRECTIONAL SIGN
	PROPOSED FULL DEPTH ASPHALT PAVEMENT REPAIR
7	PROPOSED PARKING STALL COUNT
(7)	PROPOSED TANDEM PARKING STALL COUNT
	PROPERTY LINE

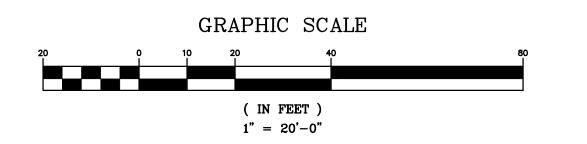



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Michael E. Dipple, P.E. New Jersey Professional Engineer #24GE04081200


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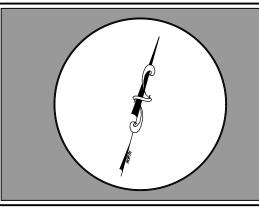
732.223.3520 (PHONE) SUR VEYOR:

MIDATLANTIC ENGINEERING PARTNERS, LLC GATEWAY 195 CENTRE 5 COMMERCE WAY, SUITE 200 HAMILTON, NJ 08691 609.910.4450 (PHONE)

ARCHITECT: STUDIO 200 ARCHITECTURE, LLC. 200 UNION AVENUE BRIELLE, NJ 08730 732.528.2240 (PHONE)



WHALERS' POINT PROPOSED MULTI-FAMILY BUILDING 2613-2615 ROUTE 88 BOROUGH OF POINT PLEASANT OCEAN COUNTY, NJ BLOCK 45, LOT 1, TAX MAP 7

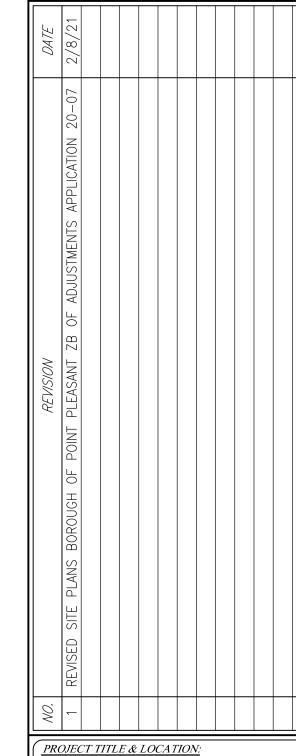


DRAWING TITLE:

SITE PLAN

REFER TO PLAN 2/8/21 DESIGNED: RPC APPROVED. MED L2A PROJ. No. 2001.223 DRAWING No..

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STORMWATER MANAGEMENT NOTE:

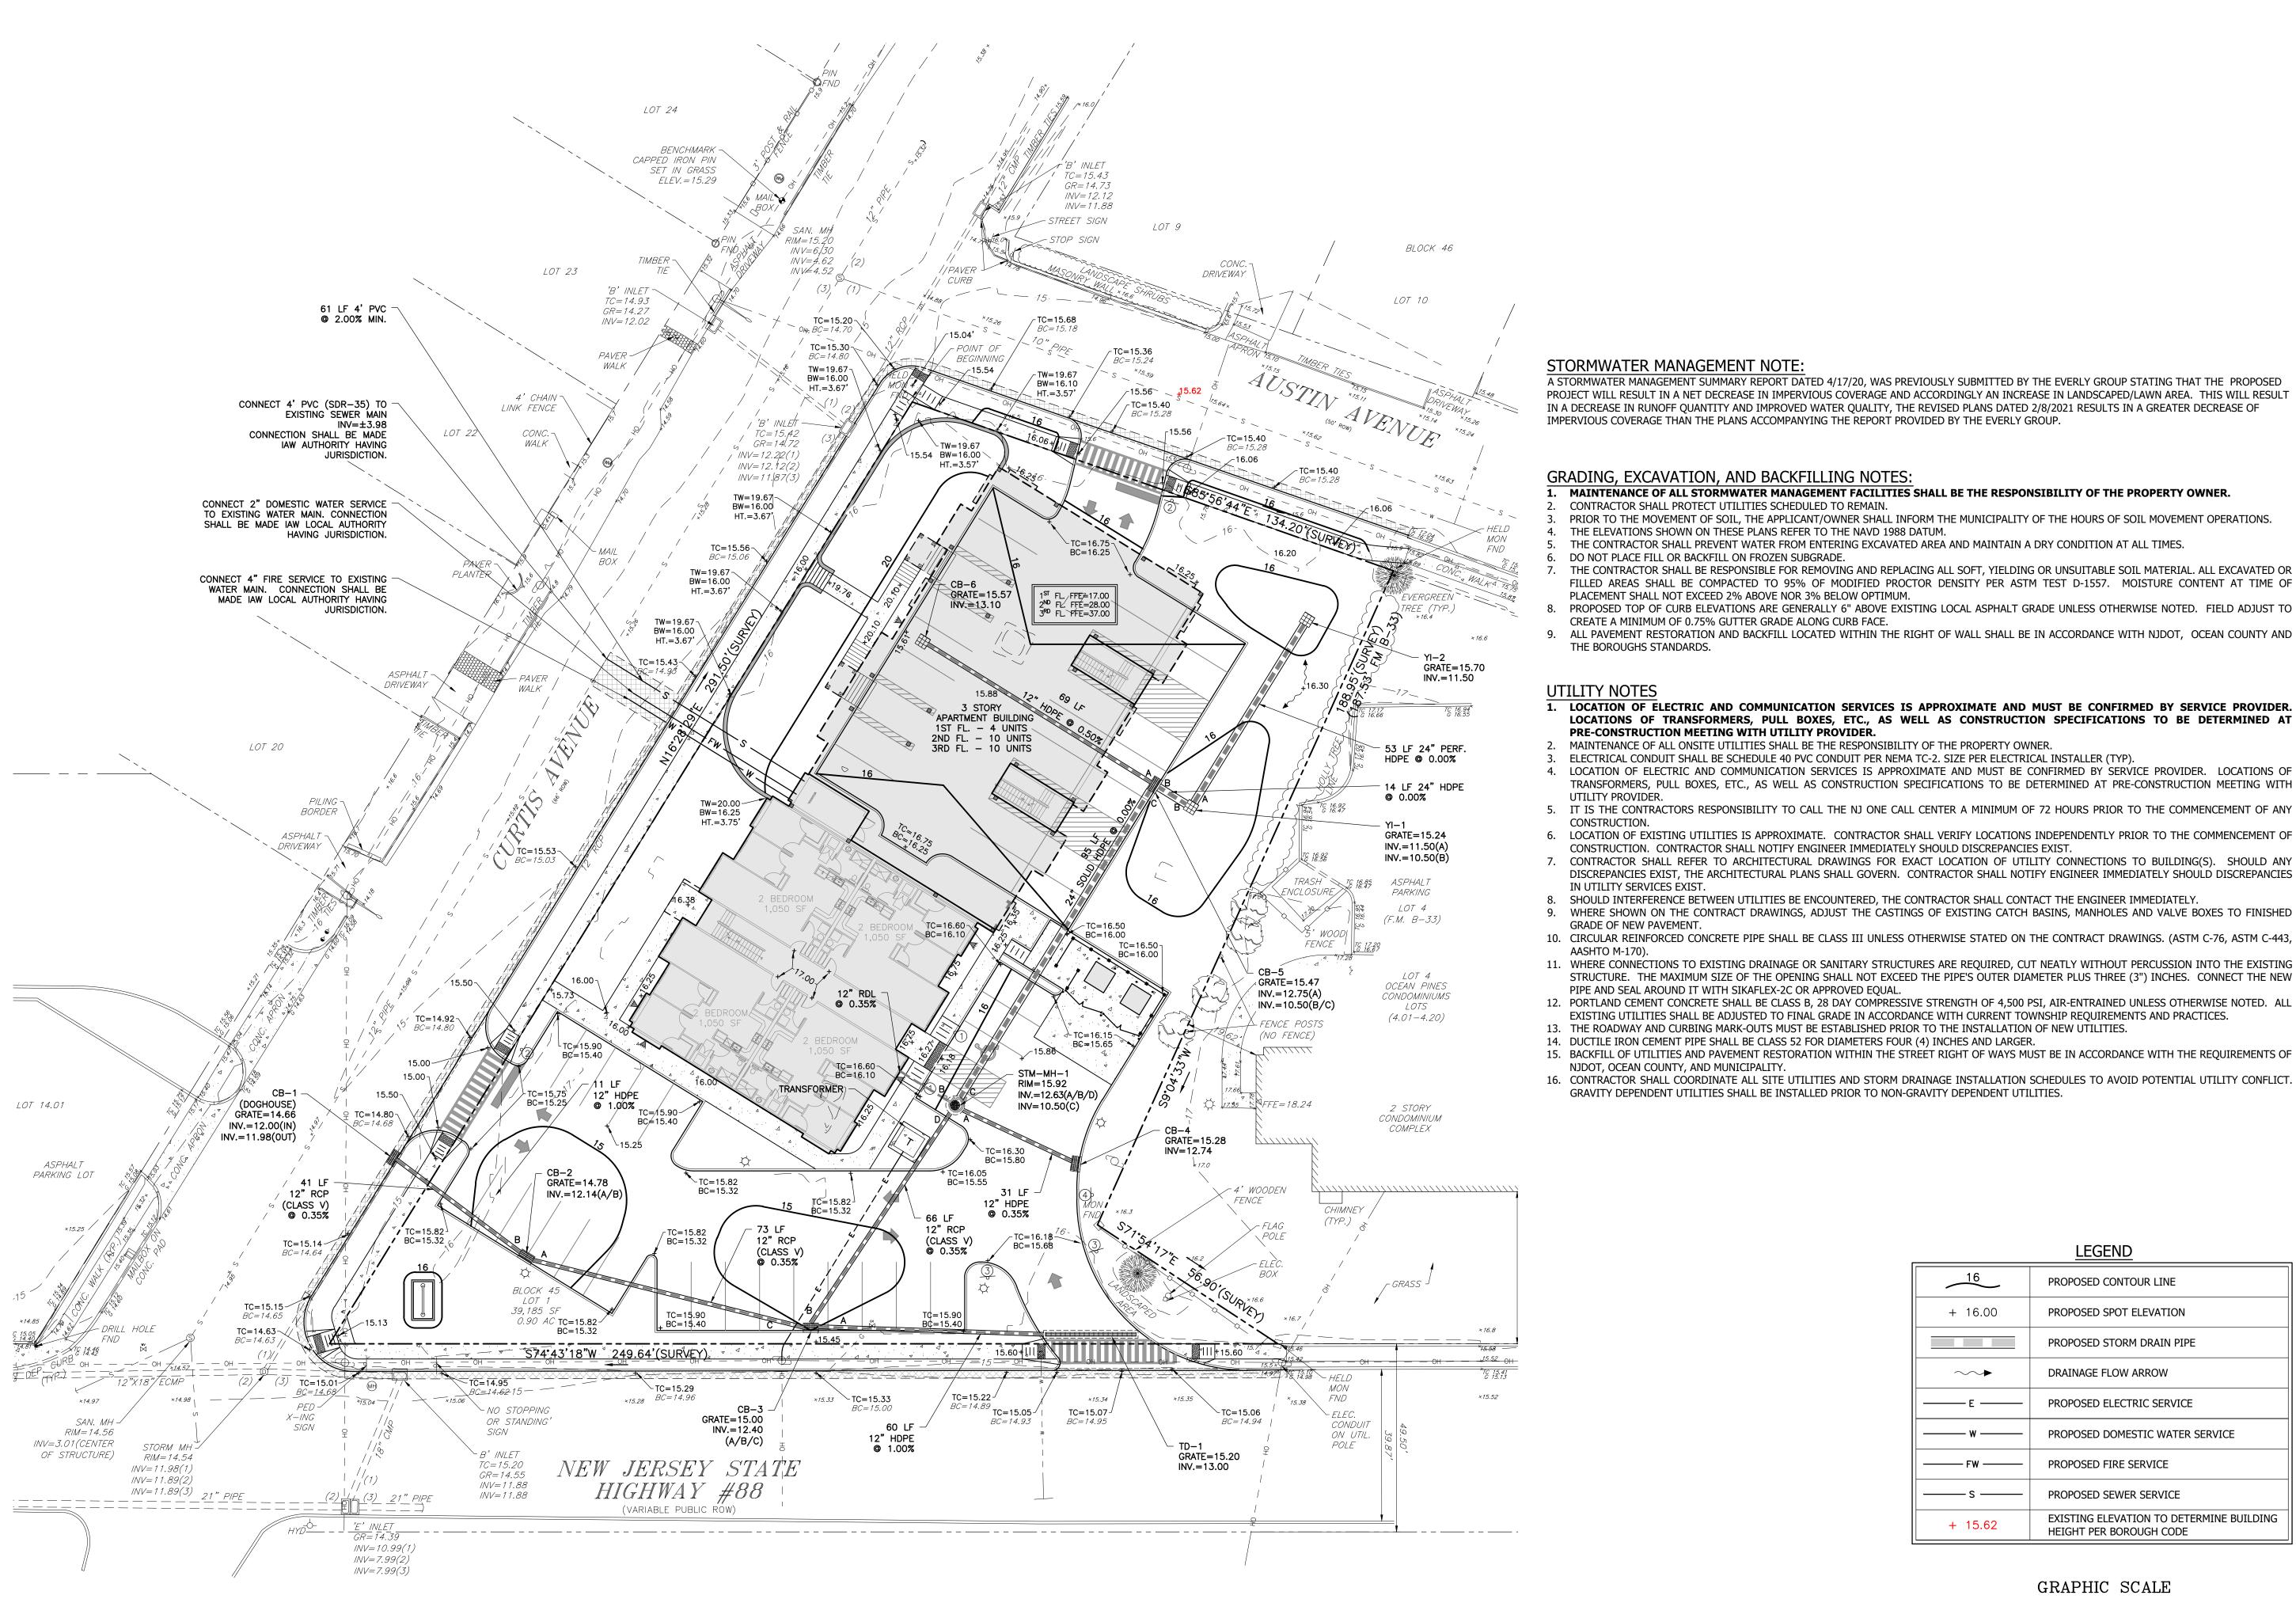A STORMWATER MANAGEMENT SUMMARY REPORT DATED 4/17/20, WAS PREVIOUSLY SUBMITTED BY THE EVERLY GROUP STATING THAT THE PROPOSED PROJECT WILL RESULT IN A NET DECREASE IN IMPERVIOUS COVERAGE AND ACCORDINGLY AN INCREASE IN LANDSCAPED/LAWN AREA. THIS WILL RESULT IN A DECREASE IN RUNOFF QUANTITY AND IMPROVED WATER QUALITY, THE REVISED PLANS DATED 2/8/2021 RESULTS IN A GREATER DECREASE OF IMPERVIOUS COVERAGE THAN THE PLANS ACCOMPANYING THE REPORT PROVIDED BY THE EVERLY GROUP.

GRADING, EXCAVATION, AND BACKFILLING NOTES:

MAINTENANCE OF ALL STORMWATER MANAGEMENT FACILITIES SHALL BE THE RESPONSIBILITY OF THE PROPERTY OWNER.

- CONTRACTOR SHALL PROTECT UTILITIES SCHEDULED TO REMAIN.
- PRIOR TO THE MOVEMENT OF SOIL, THE APPLICANT/OWNER SHALL INFORM THE MUNICIPALITY OF THE HOURS OF SOIL MOVEMENT OPERATIONS.
- THE ELEVATIONS SHOWN ON THESE PLANS REFER TO THE NAVD 1988 DATUM.
- THE CONTRACTOR SHALL PREVENT WATER FROM ENTERING EXCAVATED AREA AND MAINTAIN A DRY CONDITION AT ALL TIMES. DO NOT PLACE FILL OR BACKFILL ON FROZEN SUBGRADE.
- THE CONTRACTOR SHALL BE RESPONSIBLE FOR REMOVING AND REPLACING ALL SOFT, YIELDING OR UNSUITABLE SOIL MATERIAL. ALL EXCAVATED OR FILLED AREAS SHALL BE COMPACTED TO 95% OF MODIFIED PROCTOR DENSITY PER ASTM TEST D-1557. MOISTURE CONTENT AT TIME OF
- PLACEMENT SHALL NOT EXCEED 2% ABOVE NOR 3% BELOW OPTIMUM. PROPOSED TOP OF CURB ELEVATIONS ARE GENERALLY 6" ABOVE EXISTING LOCAL ASPHALT GRADE UNLESS OTHERWISE NOTED. FIELD ADJUST TO
- CREATE A MINIMUM OF 0.75% GUTTER GRADE ALONG CURB FACE. 9. ALL PAVEMENT RESTORATION AND BACKFILL LOCATED WITHIN THE RIGHT OF WALL SHALL BE IN ACCORDANCE WITH NJDOT, OCEAN COUNTY AND THE BOROUGHS STANDARDS.


UTILITY NOTES

1. LOCATION OF ELECTRIC AND COMMUNICATION SERVICES IS APPROXIMATE AND MUST BE CONFIRMED BY SERVICE PROVIDER. LOCATIONS OF TRANSFORMERS, PULL BOXES, ETC., AS WELL AS CONSTRUCTION SPECIFICATIONS TO BE DETERMINED AT PRE-CONSTRUCTION MEETING WITH UTILITY PROVIDER.

- MAINTENANCE OF ALL ONSITE UTILITIES SHALL BE THE RESPONSIBILITY OF THE PROPERTY OWNER.
- ELECTRICAL CONDUIT SHALL BE SCHEDULE 40 PVC CONDUIT PER NEMA TC-2. SIZE PER ELECTRICAL INSTALLER (TYP).
- LOCATION OF ELECTRIC AND COMMUNICATION SERVICES IS APPROXIMATE AND MUST BE CONFIRMED BY SERVICE PROVIDER. LOCATIONS OF TRANSFORMERS, PULL BOXES, ETC., AS WELL AS CONSTRUCTION SPECIFICATIONS TO BE DETERMINED AT PRE-CONSTRUCTION MEETING WITH
- 5. IT IS THE CONTRACTORS RESPONSIBILITY TO CALL THE NJ ONE CALL CENTER A MINIMUM OF 72 HOURS PRIOR TO THE COMMENCEMENT OF ANY
- 6. LOCATION OF EXISTING UTILITIES IS APPROXIMATE. CONTRACTOR SHALL VERIFY LOCATIONS INDEPENDENTLY PRIOR TO THE COMMENCEMENT OF CONSTRUCTION. CONTRACTOR SHALL NOTIFY ENGINEER IMMEDIATELY SHOULD DISCREPANCIES EXIST.
- 7. CONTRACTOR SHALL REFER TO ARCHITECTURAL DRAWINGS FOR EXACT LOCATION OF UTILITY CONNECTIONS TO BUILDING(S). SHOULD ANY DISCREPANCIES EXIST, THE ARCHITECTURAL PLANS SHALL GOVERN. CONTRACTOR SHALL NOTIFY ENGINEER IMMEDIATELY SHOULD DISCREPANCIES IN UTILITY SERVICES EXIST.
- 8. SHOULD INTERFERENCE BETWEEN UTILITIES BE ENCOUNTERED, THE CONTRACTOR SHALL CONTACT THE ENGINEER IMMEDIATELY. 9. WHERE SHOWN ON THE CONTRACT DRAWINGS, ADJUST THE CASTINGS OF EXISTING CATCH BASINS, MANHOLES AND VALVE BOXES TO FINISHED
- GRADE OF NEW PAVEMENT 10. CIRCULAR REINFORCED CONCRETE PIPE SHALL BE CLASS III UNLESS OTHERWISE STATED ON THE CONTRACT DRAWINGS. (ASTM C-76, ASTM C-443,
- AASHTO M-170). 11. WHERE CONNECTIONS TO EXISTING DRAINAGE OR SANITARY STRUCTURES ARE REQUIRED, CUT NEATLY WITHOUT PERCUSSION INTO THE EXISTING
- PIPE AND SEAL AROUND IT WITH SIKAFLEX-2C OR APPROVED EQUAL 12. PORTLAND CEMENT CONCRETE SHALL BE CLASS B, 28 DAY COMPRESSIVE STRENGTH OF 4,500 PSI, AIR-ENTRAINED UNLESS OTHERWISE NOTED. ALL
- EXISTING UTILITIES SHALL BE ADJUSTED TO FINAL GRADE IN ACCORDANCE WITH CURRENT TOWNSHIP REQUIREMENTS AND PRACTICES. 13. THE ROADWAY AND CURBING MARK-OUTS MUST BE ESTABLISHED PRIOR TO THE INSTALLATION OF NEW UTILITIES.
- 14. DUCTILE IRON CEMENT PIPE SHALL BE CLASS 52 FOR DIAMETERS FOUR (4) INCHES AND LARGER.
- 15. BACKFILL OF UTILITIES AND PAVEMENT RESTORATION WITHIN THE STREET RIGHT OF WAYS MUST BE IN ACCORDANCE WITH THE REQUIREMENTS OF NJDOT, OCEAN COUNTY, AND MUNICIPALITY.
- 16. CONTRACTOR SHALL COORDINATE ALL SITE UTILITIES AND STORM DRAINAGE INSTALLATION SCHEDULES TO AVOID POTENTIAL UTILITY CONFLICT. GRAVITY DEPENDENT UTILITIES SHALL BE INSTALLED PRIOR TO NON-GRAVITY DEPENDENT UTILITIES.

LEGEND

16	PROPOSED CONTOUR LINE
+ 16.00	PROPOSED SPOT ELEVATION
	PROPOSED STORM DRAIN PIPE
~ >	DRAINAGE FLOW ARROW
——Е—	PROPOSED ELECTRIC SERVICE
w	PROPOSED DOMESTIC WATER SERVICE
FW	PROPOSED FIRE SERVICE
s	PROPOSED SEWER SERVICE
+ 15.62	EXISTING ELEVATION TO DETERMINE BUILDING HEIGHT PER BOROUGH CODE

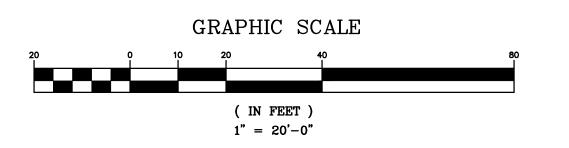



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Michael E. Dipple, P.E.

New Jersey Professional Engineer #24GE04081200


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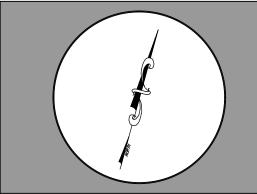
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ARCHITECT: STUDIO 200 ARCHITECTURE, LLC. 200 UNION AVENUE BRIELLE, NJ 08730 732.528.2240 (PHONE)




PROJECT TITLE & LOCATION: WHALERS' POINT PROPOSED MULTI-FAMILY BUILDING 2613-2615 ROUTE 88 BOROUGH OF POINT PLEASANT OCEAN COUNTY, NJ BLOCK 45, LOT 1, TAX MAP 7



DRAWING TITLE:

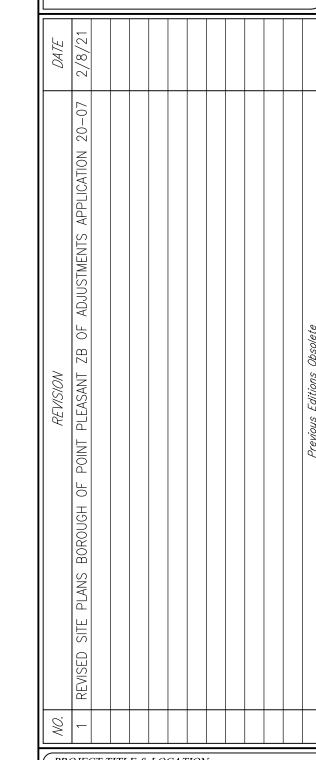GRADING, DRAINAGE, & UTILITY PLAN

REFER TO PLAN 2/8/21 DESIGNED: RPC APPROVED: MED L2A PROJ. No. 2001.223 DRAWING No.:

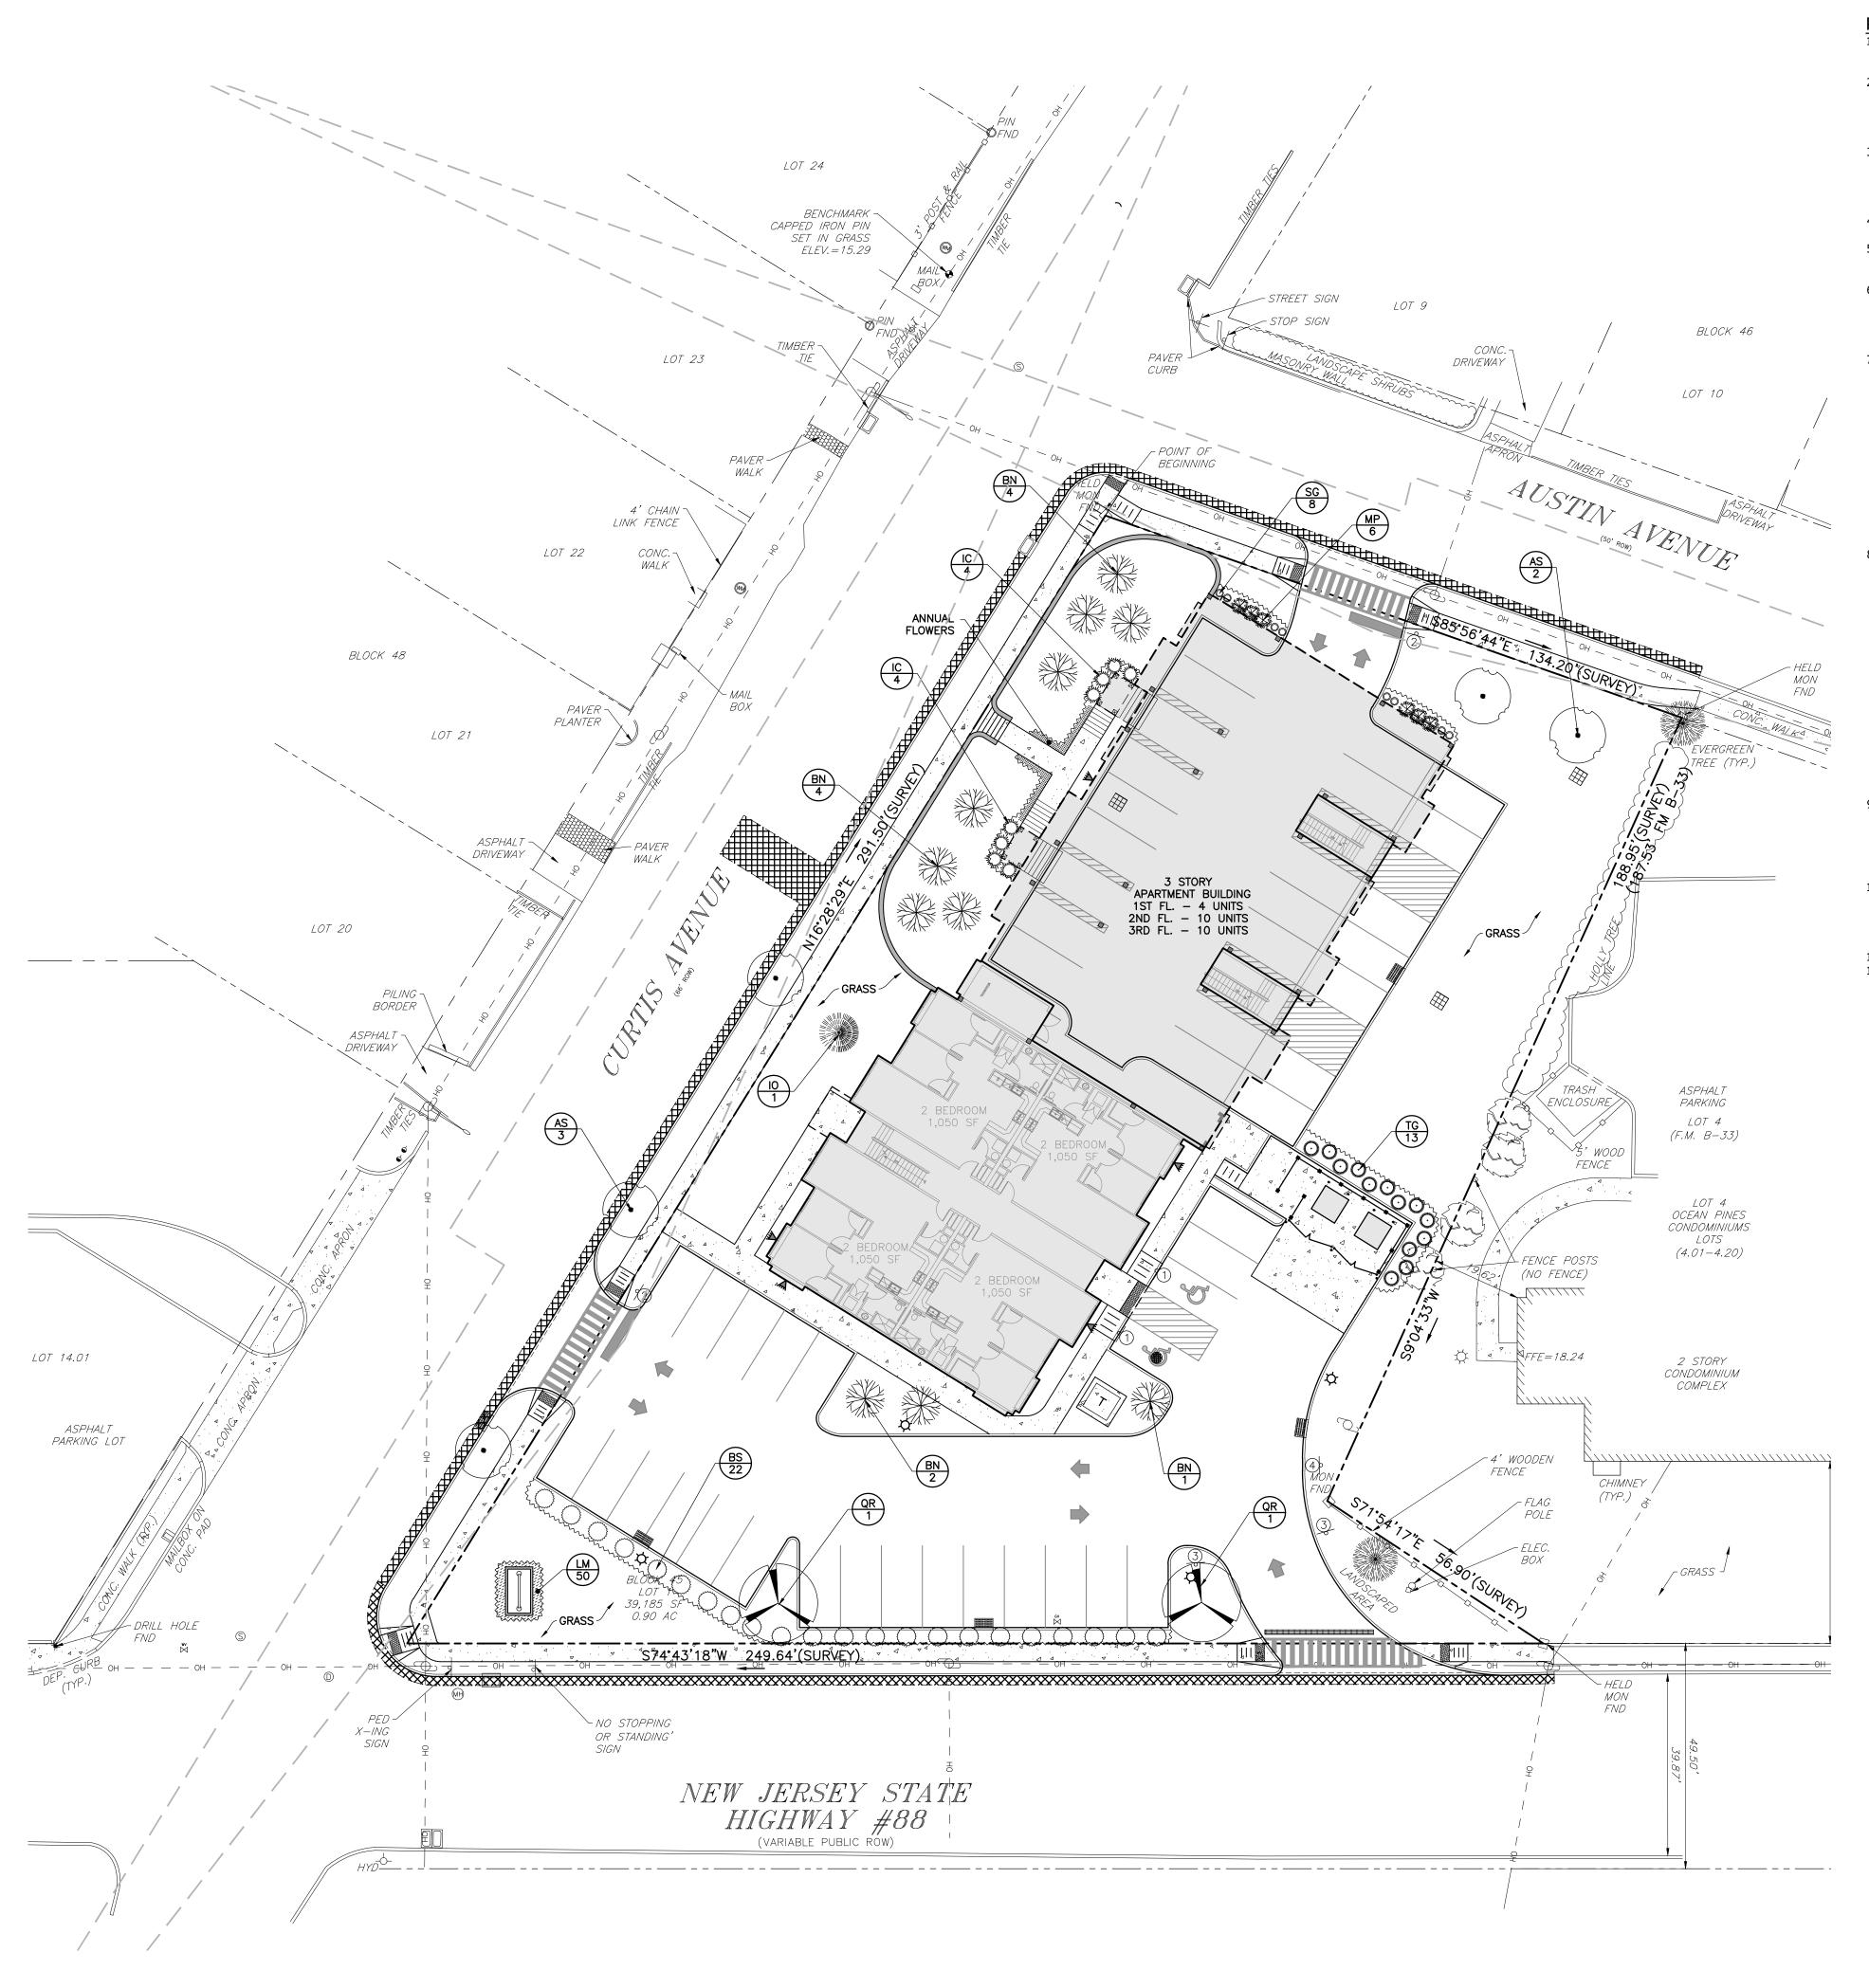


PLANTING SPECIFICATIONS

- A. THIS WORK SHALL CONSIST OF PERFORMING, CLEARING AND SOIL PREPARATION, FINISH GRADING, PLANTING AND DRAINAGE, INCLUDING ALL LABOR, MATERIALS, TOOLS, EQUIPMENT, AND ANY OTHER APPURTENANCES NECESSARY FOR THE COMPLETION OF THIS PROJECT.
- A. GENERAL ALL MATERIALS SHALL BE BEST OF ITS KIND AVAILABLE.
- B. PLANTS ALL PLANTS SHALL BE HEALTHY OR NORMAL GROWTH, WELL ROOTED, FREE FROM DISEASE AND INSECTS. C. TOPSOIL - ORGANIC TOPSOIL FREE OF DEBRIS, ROCKS LARGER THAN TWO INCHES (2"), WOOD, ROOTS, VEGETABLE MATTER AND CLAY CLODS.
- D. MULCH CEDAR BARK MULCH. 3. FERTILIZER AND SOIL CONDITIONER
- B. ORGANIC FERTILIZER AND SOIL CONDITIONER SHALL BE 'GRO- POWER' AND ORGANIC BASE MATERIALS COMPRISED OF DECOMPOSED ANIMAL AND VEGETABLE MATTER AND COMPOSTED TO SUPPORT BACTERIAL CULTURES, CONTAINING NO POULTRY, ANIMAL OR HUMAN WASTE. GUARANTEED ANALYSIS (5-3-1) NITROGEN 5%. PHOSPHATE 3%, POTASH 1%. 50% HUMUS AND 15% HUMIC ACIDS.

A. ORGANIC FERTILIZER - SHALL BE PROCESSED SEWER SLUDGE WITH MINIMAL CONTENT OF 1% NITROGEN AND 2% PHOSPHORIC ACID, EQUAL TO 'NITROHUMIS'.

- 4. GENERAL WORK PROCEDURES: LANDSCAPE WORK SHALL BE ACCORDING TO THE WORKMANLIKE STANDARDS ESTABLISHED FOR LANDSCAPE CONSTRUCTION AND PLANTING.
- BEFORE AND DURING PRELIMINARY GRADING AND FINISH GRADING, ALL WEEDS AND GRASSES SHALL BE DUG OUT BY THE ROOTS AND DISPOSED OF AT THE
- TOPSOILING: CONTRACTOR TO PROVIDE FOUR INCHES (4") MINIMUM THICK TOPSOIL LAYER IN ALL PLANTING AREAS. TOPSOIL SHOULD BE SPREAD OVER A PREPARED SURFACE IN A UNIFORM LAYER TO PRODUCE A FOUR INCH (4") COMPACTED THICKNESS. TOPSOIL PRESENT AT THE SITE, IF ANY, MAY BE USED TO SUPPLEMENT TOTAL AMOUNT REQUIRED. CONTRACTOR TO FURNISH AN ANALYSIS OF ON-SITE TOPSOIL UTILIZED IN ALL PLANTING AREAS. ADJUST pH AND NUTRIENT LEVELS AS REQUIRED TO ENSURE AN ACCEPTABLE GROWING MEDIUM.
- 7. SOIL CONDITIONING CULTIVATE ALL AREAS TO BE PLANTED TO A DEPTH OF 6". ALL DEBRIS EXPOSED FROM EXCAVATION AND CULTIVATION SHALL BE DISPOSED OF AT THE CONTRACTOR'S EXPENSE. SPREAD EVENLY IN ALL PLANTING AREAS AND TILL (2 DIRECTIONS) INTO TOP 4" WITH THE FOLLOWING PER 1,000 SQ. FT:
 - 150 POUNDS 'GRO-POWER'
 - 100 POUNDS AGRICULTURAL GYPSUM
 - 20 POUNDS NITROFORM (COURSE) 38-0-0 BLUE CHIP SOIL MODIFICATIONS:
 - THOROUGHLY TILL ORGANIC MATTER INTO THE TOP 6 TO 12 IN. OF MOST PLANTING SOILS TO IMPROVE THE SOIL'S ABILITY TO RETAIN WATER AND NUTRIENTS. USE COMPOSTED BARK, RECYCLED YARD WASTE, PEAT MOSS, OR MUNICIPAL PROCESSED SEWAGE SLUDGE. ALL PRODUCTS SHOULD BE COMPOSTED TO A DARK COLOR AND BE FREE OF PIECES WITH IDENTIFIABLE LEAF OR WOOD STRUCTURE. RECYCLED MATERIAL BY THE SUPPLIER. AVOID MATERIAL WITH A pH HIGHER THAN 7.5. MODIFY HEAVY CLAY OR SILT (MORE THAN 40% CLAY OR SILT) BY ADDING COMPOSTED PINE BARK (UP TO 30% BY VOLUME) AND/OR GYPSUM. COARSE SAND MAY BE USED IF ENOUGH IS ADDED TO BRING THE SAND CONTENT TO MORE THAN 60% OF THE TOTAL MIX. IMPROVE DRAINAGE IN HEAVY SOILS BY PLANTING ON RAISED MOUNDS OR BEDS AND INCLUDING SUBSURFACE DRAINAGE LINES. MODIFY EXTREMELY SANDY SOILS (MORE THAN 85% SAND) BY ADDING ORGANIC MATTER AND/OR DRY, SHREDDED CLAY LOAM UP TO 30% OF THE TOTAL MIX.
- PLANTING POSITION TREES AND SHRUBS AT THEIR INTENDED LOCATIONS AS PER THE PLANS AND SECURE THE APPROVAL OF THE LANDSCAPE ARCHITECT BEFORE EXCAVATING PITS, MAKING NECESSARY ADJUSTMENTS AS DIRECTED.
- A. PLANTING PITS SHALL BE DUG WITH LEVEL BOTTOMS, WITH WIDTH 1 1/2 TIMES THE DIAMETER OF ROOT BALL AND 3" DEEPER THAN THE LENGTH OF ROOT BALL. EACH PLANT PIT SHALL BE BACK FILLED WITH THE FOLLOWING PREPARED SOIL MIXED THOROUGHLY:
- -1 PART PEATMOSS; 1 PART COW MANURE BY VOLUME; 3 PARTS TOPSOIL BY VOLUME; 21 GRAM 'AGRIFORM' PLANTING TABLETS AS FOLLOWS: -2 TABLETS PER 1 GAL. PLAN; 3 TABLETS PER 5 GAL. PLANT; 4 TABLETS PER 15 GAL. PLANT; (FOR LARGER PLANTS USE TWO (2)TABLETS PER 1/2" DIAM. OF TRUNK
- B. PREPARED SOIL SHALL BE TAMPED FIRMLY AT BOTTOM OF PIT. FILL PREPARED SOIL AROUND BALL OF PLANT 1/2 WAY, AND INSERT PLANT TABLETS. COMPLETE
- BACKFILL AND WATER THOROUGHLY. C. ALL PLANTS SHALL BE SET SO THAT, THEY BEAR THE SAME RELATION TO THE REQUIRED GRADE AS THEY BORE TO THE NATURAL GRADE BEFORE BEING
- D. IMMEDIATELY AFTER PLANTING, STAKE ALL TREES TO PREVENT DAMAGE FROM WIND (LODGE-POLE STAKES LENGTH AS REQUIRED). FASTEN TREES TO UPPER END OF STAKE IN AT LEAST TWO (2) PLACES USING HOSE TYPE TIES. GUY AND STAKE TREES 3 DIRECTIONS WITH GALVANIZED WIRE, THROUGH FLEXIBLE HOSE
- CHAFING GUARDS, WITH WOODEN STAKE ANCHORS. WRAP TREE TRUNK FROM GROUND TO FIRST BRANCH WITH TREE WRAPPING TAPE. E. PREPARE RAISED EARTH BASIN AS WIDE AS PLANTING HOLE OF EACH TREE.
- F. WATER IMMEDIATELY AFTER PLANTING. WATER SHALL BE APPLIED TO EACH TREE AND SHRUB IN SUCH MANNER AS NOT TO DISTURB BACK FILL AND TO THE EXTENT THAT ALL MATERIALS IN THE PLANTING HOLE ARE THOROUGHLY SATURATED.
- G. PRUNE ALL PROPOSED TREES DIRECTLY ADJACENT TO WALKWAYS TO A MIN. OF 7' BRANCHING HEIGHT. GROUND COVER
- A. ALL GROUND COVER AREAS SHALL RECEIVE A 1/4" LAYER OF HUMUS RAKED INTO THE TOP 1" OF PREPARED SOIL PRIOR TO PLANTING GROUND COVER.
- B. SPACING AND VARIETY OF GROUND COVER SHALL BE AS SHOWN ON DRAWINGS. C. IMMEDIATELY AFTER PLANTING GROUND COVER, CONTRACTOR SHALL THOROUGHLY WATER GROUND COVER.
- D. ALL GROUND COVER AREAS SHALL BE TREATED WITH A PRE-EMERGENT BEFORE FINAL LANDSCAPE INSPECTION. GROUND COVER AREAS SHALL BE WEEDED PRIOR TO APPLYING PRE-EMERGENT. PRE-EMERGENT TO BE APPLIED AS PER MANUFACTURER'S RECOMMENDATION. 10. FINISH GRADING
- A. ALL AREAS WILL BE RECEIVED BY THE CONTRACTOR AT SUBSTANTIALLY PLUS/MINUS .1 FOOT OF FINISH GRADE.
- B. ALL LAWN AND PLANTING AREAS SHALL BE GRADED TO A SMOOTH, EVEN AND UNIFORM PLANE WITH NO ABRUPT CHANGE OF SURFACE, UNLESS OTHERWISE DIRECTED BY LANDSCAPE ARCHITECT. SOIL AREAS ADJACENT TO THE BUILDINGS SHALL SLOPE AWAY.
- C. ALL PLANTING AREAS SHALL BE GRADED AND MAINTAINED TO ALLOW FREE FLOW OF SURFACE WATER
- 11. GUARANTEE: CONTRACTOR SHALL GUARANTEE ALL PLANTS AND LAWN FOR A PERIOD OF ONE (1) YEAR FROM ACCEPTANCE OF JOB.
- 12. CLEANUP: UPON THE COMPLETION OF ALL PLANTING WORK AND BEFORE FINAL ACCEPTANCE, THE CONTRACTOR SHALL REMOVE ALL MATERIAL, EQUIPMENT, AND DEBRIS RESULTING FROM HIS WORK. ALL PAVED AREAS SHALL BE BROOM CLEANED AND THE SITE LEFT IN A NEAT AND ACCEPTABLE CONDITION AS APPROVED BY THE OWNER'S AUTHORIZED REPRESENTATIVE. MAINTAIN TREES, SHRUBS AND OTHER PLANTS BY PRUNING, CULTIVATING AND WEEDING AS REQUIRED FOR HEALTHY GROWTH. RESTORE PLANTING SAUCERS. TIGHTEN AND REPAIR STAKE AND GUY SUPPORTS AND RESET TREES AND SHRUBS TO PROPER GRADES OR VERTICAL POSITION AS REQUIRED. RESTORE OR REPLACE DAMAGED WRAPPINGS. SPRAY WITH HERBICIDE AS REQUIRED TO KEEP TREES AND SHRUBS FREE OF INSECTS AND DISEASE. MAINTAIN LAWNS BY WATERING, FERTILIZING, WEEDING, MOWING, TRIMMING, AND OTHER OPERATIONS SUCH AS ROLLING, REGRADING AND REPLANTING AS REQUIRED TO ESTABLISH A SMOOTH, ACCEPTABLE LAWN, FREE OF ERODED OR BARE AREAS.

		PLAN	TING SCHEDULE			
SYMBOL	CODE	COMMON NAME	BOTANICAL NAME	SIZE	QTY.	COND.
	BN	RIVER BIRCH	BETULA NIGRA 'HERITAGE'	12'-14' HT.	11	В&В
\bigcirc	QR	RED OAK	QUERCUS RUBRA	2"-2½" CALIPER	2	В&В
\bullet	AS	SILVER MAPLE	ACER SACCHARINUM	2"-2½" CALIPER	5	B & B
Sulling IC		JAPANESE HOLLY	ILEX CRENATA 'GREEN CLUSTER'	18"-24" HT.	8	#3 CON
	IO AMERICAN HOLLY		ILEX OPACA 24"-30" HT.		1	#5 CON
MP NOI BAY		GOLDFLAME SPIREA	SPIRAEA X BUMALDA 'GOLDFLAME'	18"-24" HT.	8	CONT.
		NORTHERN BAYBERRY	MYRICA PENNSYLVANICA	3'-4' HT.	6	CONT.
		VARIEGATED ENGLISH BOXWOOD	BUXUS SEPERVIRENS 'VARIEGATA'	3'-4' HT.	22	В&В
+	TG GREEN GIANT ARBORVITAE		THUJA PLICATA 'GREEN GIANT''	7'-8' HT.	13	В&В
	LM	LILY TURF	LIRIOPE MUSCARI	N/A	50	CONT.

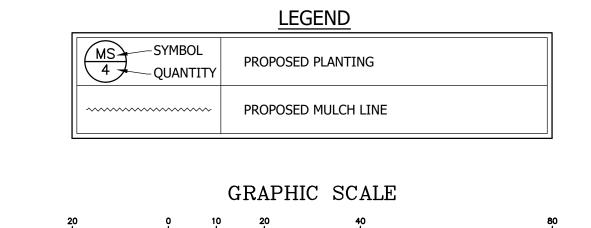

(IN FEET 1" = 20'-0"



60 GRAND AVENUE ENGLEWOOD. NJ 07631

201.227.0300 • 201.227.0001 (Fax) www.L2Alanddesign.com New Jersey Certificate of Authorization No. 24GA28130900

Michael E. Dipple, P.E.

New Jersey Professional Engineer #24GE04081200

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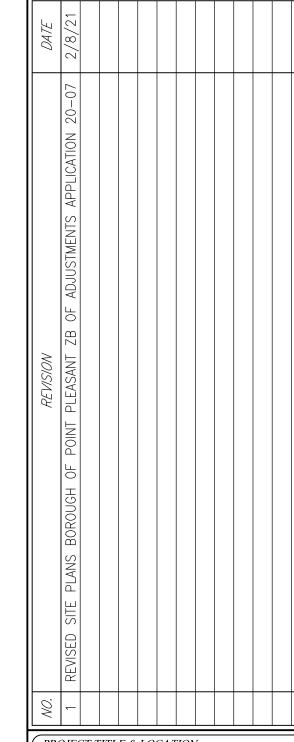
OWNER/APPLICANT: R2T2, LLC 1103 INDUSTRIAL PARKWAY

BRICK, NJ 08724 732.223.3520 (PHONE)


SURVEYOR: MIDATLANTIC ENGINEERING PARTNERS, LLC GATEWAY 195 CENTRE 5 COMMERCE WAY, SUITE 200 HAMILTON, NJ 08691

ARCHITECT: STUDIO 200 ARCHITECTURE, LLC. 200 UNION AVENUE BRIELLE, NJ 08730 732.528.2240 (PHONE)

609.910.4450 (PHONE)



PROJECT TITLE & LOCATION: WHALERS' POINT PROPOSED MULTI-FAMILY BUILDING 2613-2615 ROUTE 88 BOROUGH OF POINT PLEASANT OCEAN COUNTY, NJ BLOCK 45, LOT 1, TAX MAP 7

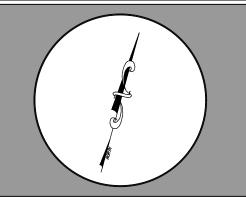

DRAWING TITLE:

LANDSCAPING **PLAN**

REFER TO PLAN 2/8/21 DESIGNED: RPC APPROVED. MED L2A PROJ. No.. 2001.223 DRAWING No..

C-06






VCPG LED PARKING GARAGE **CANOPY MOUNTED** (OR APPROVED EQUAL)



WALL MOUNT (OR APPROVED EQUAL)

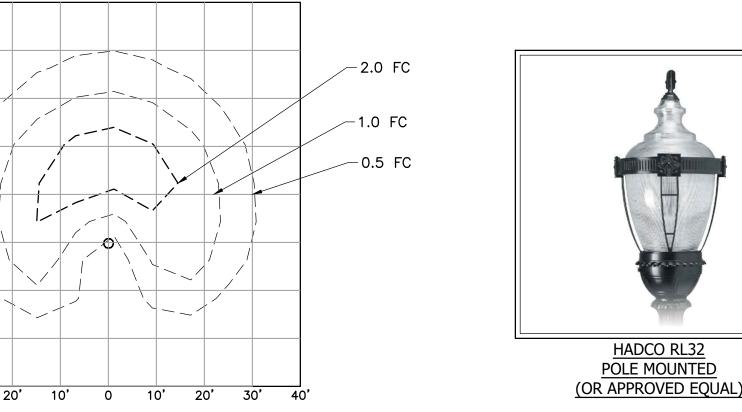

___ 2.0 FC

∕-1.0 FC

___0.5 FC

∕-2.0 FC

−1.0 FC

∕-0.5 FC

LITHONIA LIGHTING -

ISOLUX PATTERN

10' 0 10' 20' 30' 40'

RAB LIGHTING -

ISOLUX PATTERN

HADCO BY SIGNIFY -


LED POST-TOP (RL32)

TYPE 3 DISTRIBUTION

ISOLUX PATTERN

LIGHTING LEGEND

	ILLUMINATION CONTOUR
+ 0.5	ILLUMINATION LEVEL IN FOOTCANDLES
•	PROPOSED GARAGE/ CANOPY LIGHT
₫	PROPOSED WALL SCONCE
\$	PROPOSED POLE MOUNTED POST-TOP LIGHT

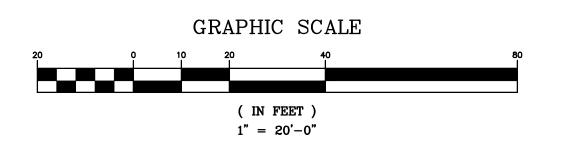



New Jersey Certificate of Authorization No. 24GA28130900

www.L2Alanddesign.com

Michael E. Dipple, P.E. New Jersey Professional Engineer #24GE04081200

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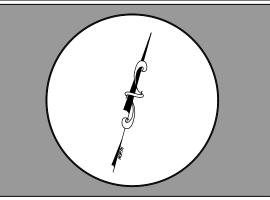
732.223.3520 (PHONE) SURVEYOR:

MIDATLANTIC ENGINEERING PARTNERS, LLC GATEWAY 195 CENTRE 5 COMMERCE WAY, SUITE 200 HAMILTON, NJ 08691 609.910.4450 (PHONE)

ARCHITECT: STUDIO 200 ARCHITECTURE, LLC. 200 UNION AVENUE BRIELLE, NJ 08730 732.528.2240 (PHONE)

DATE	2/8/21						
REVISION	REVISED SITE PLANS BOROUGH OF POINT PLEASANT ZB OF ADJUSTMENTS APPLICATION 20-07 2/8/21						Previous Fditions Obsolete
NO.	_						

PROJECT TITLE & LOCATION: WHALERS' POINT PROPOSED MULTI-FAMILY BUILDING 2613-2615 ROUTE 88 BOROUGH OF POINT PLEASANT OCEAN COUNTY, NJ BLOCK 45, LOT 1, TAX MAP 7



DRAWING TITLE:

LIGHTING PLAN

		_
SCALE:	REFER TO PLAN	
DATE	2/8/21	
DESIGNED:	RPC	
APPROVED:	MED	
L2A PROJ. No.:	2001.223	
DRAWING No.:		

<u>DEFINTION:</u>

1. THE CONTROL OF DUST ON CONSTRUCTION SITES AND ROADS.

1. TO PREVENT BLOWING AND MOVEMENT OF DUST FROM EXPOSED SOIL SURFACES, REDUCED ON-SITE AND OFF-SITE DAMAGE IS LIKELY WITHOUT TREATMENT. CONSULT WITH LOCAL MUNICIPAL ORDINANCES ON ANY RESTRICTIONS.

CONDITION WHERE PRACTICE APPLIES: I. THIS PRACTICE IS APPLICABLE TO AREAS SUBJECT TO DUST BLOWING AND MOVEMENT WHERE ON-SITE AND OFF-SITE

DAMAGE IS LIKELY WITHOUT A TREATMENT. CONSULT WITH LOCAL MUNICIPAL ORDINANCES ON ANY RESTRICTIONS.

1. SEDIMENTS DEPOSITED AS "DUST" ARE OFTEN FINE COLLOIDAL MATERIAL WHICH IS EXTREMELY DIFFICULT TO REMOVE FROM WATER ONCE IT BECOMES SUSPENDED. USE OF THIS STANDARD WILL HELP TO CONTROL THE GENERATION OF DUST FROM CONSTRUCTION SITES AND SUBSEQUENT BLOWING AND DEPOSITION INTO LOCAL SURFACE WATER RESOURCES.

THE FOLLOWING METHODS SHOULD BE CONSIDERED FOR CONTROLLING DUST:

MULCHES - SEE STANDARD OF STABILIZATION WITH MULCHES ONLY, PG. 5-1

ÆGETATIVE COVER - SEE STANDARD FOR: TEMPORARY VEGETATIVE COVER, PG. 7-1, PERMANENT VEGETATIVE COVER FOR SOIL STABILIZATION PG. 4-1, AND PERMANENT STABILIZATION WITH SOD, PG. 6-1.

SOIL RESTORATION, DE-COMPACTION, AND TESTING REQUIREMENTS:

SOIL COMPACTION TESTING REQUIREMENTS

SUBGRADE SOILS PRIOR TO THE APPLICATION OF TOPSOIL (SEE PERMANENT SEEDING AND STABILIZATION NOTES FOR TOPSOIL REQUIREMENTS) SHALL BE FREE OF EXCESSIVE COMPACTION TO A DEPTH

OF 6.0 INCHES TO ENHANCE THE ESTABLISHMENT OF PERMANENT VEGETATIVE COVER.

1. AREAS OF THE SITE WHICH ARE SUBJECT TO COMPACTION TESTING AND/OR MITIGATION ARE **GRAPHICALLY DENOTED** ON THE CERTIFIED SOIL EROSION CONTROL PLAN. . COMPACTION TESTING LOCATIONS ARE DENOTED ON THE PLAN. A COPY OF THE PLAN OR PORTION OF THE PLAN SHALL BE USED TO MARK LOCATIONS OF TESTS, AND ATTACHED TO THE COMPACTION MITIGATION VERIFICATION FORM, AVAILABLE FROM THE LOCAL SOIL CONSERVATION DISTRICT. THIS FORM MUST BE FILLED OUT AND SUBMITTED PRIOR TO RECEIVING A CERTIFICATE OF COMPLIANCE

FROM THE DISTRICT. 3. IN THE EVENT THAT TESTING INDICATES COMPACTION IN EXCESS OF THE MAXIMUM THRESHOLDS INDICATED FOR THE SIMPLIFIED TESTING METHODS (SEE DETAILS BELOW), THE CONTRACTOR/OWNER SHALL HAVE THE OPTION TO PERFORM EITHER (1) COMPACTION MITIGATION OVER THE ENTIRE MITIGATION AREA DENOTED ON THE PLAN (EXCLUDING EXEMPT AREAS), OR (2) PERFORM ADDITIONAL, MORE DETAILED TESTING TO ESTABLISH THE LIMITS OF EXCESSIVE COMPACTION WHEREUPON ONLY THE EXCESSIVELY COMPACTED AREAS WOULD REQUIRE COMPACTION MITIGATION. ADDITIONAL DETAILED TESTING SHALL BE PERFORMED BY A TRAINED, LICENSED PROFESSIONAL

COMPACTION TESTING METHODS

A. PROBING WIRE TEST (SEE DETAIL)

B. HAND-HELD PENETROMETER TEST (SEE DETAIL)

C. TUBE BULK DENSITY TEST (LICENSED PROFESSIONAL ENGINEER REQUIRED D. NUCLEAR DENSITY TEST (LICENSED PROFESSIONAL ENGINEER REQUIRED)

NOTE: ADDITIONAL TESTING METHODS WHICH CONFORM TO ASTM STANDARDS AND SPECIFICATIONS, AND WHICH PRODUCE A DRY WEIGHT, SOIL BULK DENSITY MEASUREMENT MAY BE ALLOWED SUBJECT TO DISTRICT APPROVAL.

SOIL COMPACTION TESTING IS NOT REQUIRED IF/WHEN SUBSOIL COMPACTION REMEDIATION (SCARIFICATION/TILLAGE (6" MINIMUM DEPTH) OR SIMILAR) IS PROPOSED AS PART OF THE SEQUENCE OF CONSTRUCTION.

SPRAY-ON ADHESIVES - ON MINERAL SOILS (NOT EFFECTIVE ON MUCK SOILS). KEEP TRAFFIC OFF THESE AREAS. PROCEDURES FOR SOIL COMPACTION MITIGATION PROCEDURES SHALL BE USED TO MITIGATE EXCESSIVE SOIL COMPACTION PRIOR TO PLACEMENT OF TOPSOIL AND ESTABLISHMENT OF PERMANENT VEGETATIVE COVER RESTORATION OF COMPACTED SOILS SHALL BE THROUGH DEEP SCARIFICATION/TILLAGE (6" MINIMUM DEPTH) WHERE THERE IS NO DANGER TO UNDERGROUND UTILITIES (CABLES, IRRIGATION 61 LF 4' PVC SYSTEMS, ETC.). IN THE ALTERNATIVE, ANOTHER METHOD AS SPECIFIED BY A NEW JERSEY LICENSED PROFESSIONAL ENGINEER MAYBE SUBSTITUTED SUBJECT TO DISTRICT APPROVAL. @ 2.00% MIN. OK. BC=14.70 (TYP) TC=15.30 \ - POINT OF r TC = 15.36PAVER -BC = 14.80BC = 15.24WALK HT.=3.67' CONNECT 4' PVC (SDR-35) TO LINK FENCE EXISTING SEWER MAIN INV = +3.98CONC. ¬ CONNECTION SHALL BE MADE TC = 15.42GR = 14.72IAW AUTHORITY HAVING LIMTS OF JURISDICTION. INV=12.2/2(1 DISTURBANCE INV = 12.12(2INV = 11.87(TW = 19.67CONNECT 2" DOMESTIC WATER SERVICE -BW = 16.00TO EXISTING WATER MAIN. CONNECTION HT = 3.67SHALL BE MADE IAW LOCAL AUTHORITY HAVING JURISDICTION. BC=16.25 CONNECT 4" FIRE SERVICE TO EXISTING -WATER MAIN. CONNECTION SHALL BE 1ST FL. FFE≠17.00 2ND FL. FFE=28.00 GRATE=15.57 MADE IAW LOCAL AUTHORITY HAVING JURISDICTION. 3RD FL. PFE=37.00 TW=19.67-BW = 16.00HT.=3.67GRATE=15.70 **ASPHALT** INV = 11.50DRIVEWAY 3 STORY APARTMENT BUILDING SILT FENCE -1ST FL. - 4 UNITS (TYP) 2ND FL. - 10 UNITS LOT 20 3RD/FL. - 10 UNITS 53 LF 24" PERF. HDPE @ 0.00% 14 LF 24" HDPE @ 0.00% PILING . **BORDER** GRATE=15.24 ASPHALT DRIVEWAY INV.=11.50(A)INV.=10.50(B)PARKING LIMITS OF DISTURBANCE LOT 4 (F.M. B-33)

CONSTRUCTION

O TO 5% SLOPES

[SOIL RATING A

ASPHALT

PARKING LOT

RIM = 14.56

STORM MH -

R/M = 14.54

INV = 11.98(1)

INV = 11.89(2)

INV = 11.89(3)

INV=3.01(CENTER

OF STRUCTURE)

DOGHOUSE) LOT 14.01 GRATE=14.66 INV.=12.00(IN)

INV.=11.98(OUT)

12" RCP 6 (CLASS V) / @ 0.35% COMPACTION TESTING LOCATION(TYP)

INV = 10.99(1)

INV = 7.99(2)

INV = 7.99(3)

CB-3 -GRATE=15.00 OR STANDING INV.=12.40SIGN (A/B/C)

0.90 AC TC=15.82~

39.185 SF

GR = 14.55INV = 11.88/NV=11.88

 $\Gamma C = 15.22 \sim$ TC=15.33 ×15.34 BC = 14.89BC = 15.00/ TC=15.07 [/] TC = 15.05 $\sim TC = 15.06$ BC = 14.93BC = 14.95BC = 14.9412" HDPE GRATE=15.20 INV. = 13.00LIMITS OF

BC=15.65

RIM = 15.92

BC = 15.80

12" HDPE @ 0.35%

DISTURBANCE

(TYP)

(CLASS V) @ 0.35%

INV = 10.50(C)

INV.=12.63(A/B/D)

FENCE

CHIMNE

CONDUIT

ON UTIL

GRATE=15.47

INV.=12.75(A)

(NO FENCE)

7.55 FFE=18.24

~ 4' WOODEN

FENCE

GRATE=15.28

INV = 12.74

SILT FENCE

INV.=10.50(B/C)

LOT 4

OCEAN PINES

(4.01-4.20)

2 STORY

CONDOMINIUM

COMPLEX

CONDOMINIUMS

4", FIRMED IN PLACE. (1 WEEK)

INSTALL PERMANENT LANDSCAPING. (2 WEEKS)

. INSTALL ASPHALT PAVEMENT AND ALL CONCRETE. (1 MONTH)

STABILIZATION MEASURES. (1 WEEK)

LIMIT OF DISTURBANCE = 47,026 SF (1.08 AC.)

OCSD SOIL EROSION AND SEDIMENT CONTROL NOTES (LAST REV. 2/19/19):

THE OCEAN COUNTY SOIL CONSERVATION DISTRICT SHALL BE NOTIFIED FORTY-EIGHT (48) HOURS IN ADVANCE OF ANY LAND DISTURBANCE. 2. ALL WORK IS TO BE DONE IN ACCORDANCE WITH THE STATE STANDARDS FOR SOIL EROSION AND SEDIMENT CONTROL IN NEW JERSEY.

3. ALL SOIL EROSION AND SEDIMENT CONTROL PRACTICES ARE TO BE INSTALLED PRIOR TO ANY MAJOR SOIL DISTURBANCE OR IN THEIR PROPER SEQUENCE AND MAINTAINED

UNTIL PERMANENT PROTECTION IS ESTABLISHED. ANY CHANGES TO THE CERTIFIED SOIL EROSION AND SEDIMENT CONTROL PLANS WILL REQUIRE THE SUBMISSION OF REVISED SOIL EROSION AND SEDIMENT CONTROL PLANS TO THE DISTRICT. THE REVISED PLANS MUST MEET ALL CURRENT "THE STANDARDS FOR SOIL EROSION AND SEDIMENT CONTROL AND SEDIMENT CONTROL IN NEW JERSEY, 7TH

EDITION, JANUARY 2014, REVISED JULY 2017. LINK TO 2014 STANDARDS: HTTP://WWW.STATE.NJ.US/AGRICULTURE/DIVISIONS/ANR/NRC/NJEROSION.HTML

5. N.J.S.A 4:24-39 ET SEQ. REQUIRES THAT NO CERTIFICATES OF OCCUPANCY BE ISSUED BEFORE THERE HAS BEEN COMPLIANCE WITH PROVISIONS OF A CERTIFIED PLAN FOR PERMANENT MEASURES. ALL SITE WORK, AND ALL WORK AROUND INDIVIDUAL LOTS IN SUBDIVISIONS, MUST BE COMPLETED PRIOR TO THE DISTRICT ISSUING A REPORT OF COMPLIANCE FOR THE ISSUANCE OF A CERTIFICATE OF OCCUPANCY BY THE MUNICIPALITY.

6. ANY DISTURBED AREAS THAT WILL BE LEFT EXPOSED MORE THAN SIXTY (60) DAYS, AND NOT SUBJECT TO CONSTRUCTION TRAFFIC, WILL IMMEDIATELY RECEIVE A TEMPORARY SEEDING. IF THE SEASON PREVENTS THE ESTABLISHMENT OF TEMPORARY COVER, THE DISTURBED AREAS WILL BE MULCHED WITH STRAW, OR EQUIVALENT MATERIAL WITHIN 14 DAYS, AT A RATE OF 2 TO 2 1/2 TONS PER ACRE, ACCORDING TO STATE STANDARD FOR STABILIZATION WITH MULCH ONLY.

. IMMEDIATELY FOLLOWING INITIAL DISTURBANCE OR ROUGH GRADING, ALL CRITICAL AREAS SUBJECT TO EROSION (I.E. STEEP SLOPES AND ROADWAY EMBANKMENTS) WILL RECEIVE TEMPORARY SEEDING IN COMBINATION WITH STRAW MULCH OR A SUITABLE EQUIVALENT, AT A RATE OF 1 ½ TO 2 TONS PER ACRE, ACCORDING TO STATE STANDARDS. 8. A SUB-BASE COURSE WILL BE APPLIED IMMEDIATELY FOLLOWING ROUGH GRADING AND INSTALLATION OF IMPROVEMENTS TO STABILIZE STREETS, ROADS, DRIVEWAYS, AND

PARKING AREAS. IN AREAS WHERE NO UTILITIES ARE PRESENT, THE SUB-BASE SHALL BE INSTALLED WITHIN FIFTEEN (15) DAYS OF THE PRELIMINARY GRADING. 9. ANY STEEP SLOPES (3:1 OR GREATER) OR ANY EXISTING ROADWAYS RECEIVING PIPELINE INSTALLATION WILL BE BACKFILLED AND STABILIZED DAILY, AS THE INSTALLATION

CONTINUES. 10. THE STANDARD FOR STABILIZED CONSTRUCTION ACCESS REQUIRES THE INSTALLATION OF A STONE PAD USING CLEAN CRUSHED ANGULAR STONE (ASTM C-33, SIZE NO. 2 OR 3) AT ALL CONSTRUCTION DRIVEWAYS WHERE VEHICLES WILL ACCESS PAVED ROADWAYS FROM UNPAVED AREAS OF THE SITE.

11. ALL SEDIMENT WASHED, DROPPED, SPILLED, OR TRACKED ONTO ROADWAYS (PUBLIC OR PRIVATE) OR OTHER IMPERVIOUS SURFACES WILL BE REMOVED IMMEDIATELY.

12. PERMANENT VEGETATION IS TO BE SEEDED OR SODDED ON ALL EXPOSED AREAS WITHIN TEN (10) DAYS AFTER FINAL GRADING. AT THE TIME OF THE FINAL INSPECTION, YOU ARE REQUIRED TO PROVIDE CONFIRMATION THAT THE PROPER TYPE AND AMOUNT OF SEED, LIME AND FERTILIZER HAVE BEEN USED FOR PERMANENT STABILIZATION WORK. STRAW 13. AT THE TIME THAT SITE PREPARATION FOR PERMANENT VEGETATIVE STABILIZATION IS GOING TO BE ACCOMPLISHED, ANY SOIL THAT WILL NOT PROVIDE A SUITABLE

ENVIRONMENT TO SUPPORT ADEQUATE VEGETATIVE GROUND COVER SHALL BE REMOVED OR TREATED IN SUCH A WAY THAT IT WILL PERMANENTLY ADJUST THE SOIL CONDITIONS AND RENDER IT SUITABLE FOR VEGETATIVE GROUND COVER. IF THE REMOVAL OR TREATMENT OF THE SOIL WILL NOT PROVIDE SUITABLE CONDITIONS NON-VEGETATIVE MEANS OF PERMANENT GROUND STABILIZATION WILL HAVE TO BE EMPLOYED.

4. IN ACCORDANCE WITH THE STANDARD FOR MANAGEMENT OF HIGH ACID PRODUCING SOILS, ANY SOIL HAVING A PH OF 4 OR LESS OR CONTAINING IRON SULFIDES SHALL BE COVERED WITH A MINIMUM OF TWELVE (12) INCHES OF SOIL HAVING A PH OF 5 OR MORE PRIOR TO SEEDBED PREPARATION. AREAS WHERE TREES OR SHRUBS ARE TO BE PLANTED SHALL BE COVERED WITH A MINIMUM OF TWENTY-FOUR (24) INCHES OF SOIL HAVING A PH OF 5 OR MORE . CONDUIT OUTLET PROTECTION MUST BE INSTALLED AT ALL REQUIRED OUTFALLS PRIOR TO THE DRAINAGE SYSTEM BECOMING OPERATIONAL. CONDUIT OUTLET PROTECTION IS

NOT REQUIRED IN BASINS ACTING AS SEDIMENT BASINS DURING CONSTRUCTION. 16. UNFILTERED DEWATERING IS NOT PERMITTED. NECESSARY PRECAUTIONS MUST BE TAKEN DURING ALL DEWATERING OPERATIONS TO MINIMIZE SEDIMENT TRANSFER. ANY

DEWATERING METHODS USED MUST BE IN ACCORDANCE WITH THE STANDARD FOR DEWATERING. 17. SHOULD THE CONTROL OF DUST AT THE SITE BE NECESSARY, THE SITE WILL BE SPRINKLED UNTIL THE SURFACE IS WET, TEMPORARY VEGETATIVE COVER SHALL BE ESTABLISHED

OR MULCH SHALL BE APPLIED AS REQUIRED BY THE STANDARD FOR DUST CONTROL. 18. STOCKPILE AND STAGING LOCATIONS ESTABLISHED IN THE FIELD SHALL BE PLACED WITHIN THE LIMIT OF DISTURBANCE ACCORDING TO THE CERTIFIED PLAN. STAGING AND STOCKPILES NOT LOCATED WITHIN THE LIMIT OF DISTURBANCE WILL REQUIRE CERTIFICATION OF A REVISED SOIL EROSION AND SEDIMENT CONTROL PLAN. THE DISTRICT RESERVES THE RIGHT TO DETERMINE WHEN CERTIFICATION OF A NEW AND SEPARATE SOIL EROSION AND SEDIMENT CONTROL PLAN WILL BE REQUIRED FOR THESE ACTIVITIES. 19. ALL SOIL STOCKPILES ARE TO BE TEMPORARILY STABILIZED IN ACCORDANCE WITH SOIL EROSION AND SEDIMENT CONTROL NOTE #6. STOCKPILES SHOULD BE SITUATED SO AS TO NOT OBSTRUCT NATURAL DRAINAGE OR CAUSE OFF-SITE ENVIRONMENTAL DAMAGE.

20. THE PROPERTY OWNER SHALL BE RESPONSIBLE FOR ANY EROSION OR SEDIMENTATION THAT MAY OCCUR BELOW STORMWATER OUTFALLS OR OFFSITE AS A RESULT OF CONSTRUCTION OF THE PROJECT.

SOIL STABILIZATION AND MAINTENANCE NOTES:

STABILIZATION SPECIFICATIONS

TEMPORARY SEEDING AND MULCHING - LIME: 90 LBS./1,000 SF GROUND LIMESTONE

- FERTILIZER: 11 LBS./1,000 SF AT 10-20-10 OR EQUIVALENT WORKED INTO THE SOIL AT A MINIMUM OF FOUR (4") INCHES.

- SEED: PERENNIAL RYEGRASS 40 LBS./ACRE (1LB./1,000 SF) OR OTHER APPROVED SEEDS. PLANT BETWEEN MARCH 1ST AND MAY 15TH OR BETWEEN AUGUST 15TH AND

- MULCH: SALT HAY OR SMALL GRAINS STRAW AT A RATE OF 70 LBS. TO 90 LBS./1,000 SF TO BE APPLIES ACCORDING TO THE NEW JERSEY STANDARDS. MULCH SHALL BE SECURED BY APPROVED METHODS SUCH AS PEG AND TWINE, MULCH NETTING, OR LIQUID MULCH BINDER.

B. PERMANENT SEEDING AND MULCHING: topsoil: Uniformly apply topsoil to an average depth of 5", minimum of 4", firmed in place.

- LIME: 90 LBS./1,000 SF GROUND LIMESTONE - FERTILIZER: 11 LBS./1,000 SF AT 10-20-10 OR EQUIVALENT WORKED INTO A SOIL A MINIMUM OF 4"

- SEED: TURF TYPE TALL FESCUE (BLEND OF THREE CULTIVARS) 150 LBS./ACRE (3.5 LBS./1,000 SF) OR OTHER APPROVED SEEDS. PLANT BETWEEN MARCH 1ST AND NOVEMBER

- MULCH: SALT HAY OR SMALL GRAIN STRAW AT A RATE OF 70 LBS. TO 90 LBS./1,000 SF TO BE APPLIED AS PER NEW JERSEY STANDARDS. MULCH SHALL BE SECURED BY APPROVED METHODS SUCH AS PEG & TWINE, MULCH NETTING OR LIQUID MULCH BINDER. C. STABILIZATION WITH MULCH ONLY

APPLICABLE IN AREAS SUBJECT TO EROSION WHERE THE SEASON AND OTHER CONDITIONS MAY NOT BE SUITABLE FOR GROWING AN EROSION-RESISTANT COVER OR WHERE STABILIZATION IS NEEDED FOR A SHORT PERIOD UNTIL MORE SUITABLE PROTECTION CAN BE APPLIED.

A. GRADE AS NEEDED AND FEASIBLE TO PERMIT THE USE OF CONVENTIONAL EQUIPMENT FOR APPLYING AND ANCHORING MULCH. ALL GRADING SHALL BE DONE IN ACCORDANCE

WITH THE NEW JERSEY STANDARDS FOR LAND GRADING. B. EMPLOY NEEDED EROSION CONTROL PRACTICES SUCH AS DIVERSION GRADE STABILIZATION STRUCTURES, CHANNEL STABILIZATION MEASURES, SEDIMENT BASIN AND

PROTECTIVE MATERIALS A. UNROLL SMALL-GRAIN STRAW OR SALT HAY AT 2.0 TONS TO 2.5 TONS PER ACRE AND SPREAD UNIFORMLY AT 90 LBS. TO 115 LBS./1,000 SF AND ANCHORED WITH A MULCH ANCHORING TOOL, LIOUID MULCH BINDER, OR A NETTING TIE-DOWN. OTHER SUITABLE MATERIALS MAY BE USED IF APPROVED BY THE SOIL CONSERVATION DISTRICT. B. ASPHALT EMULSION IS RECOMMENDED AT THE RATE OF 600 GAL. TO 1,200 GAL./ACRE. THIS IS SUITABLE FOR A LIMITED PERIOD OF TIME WHERE TRAVEL BY PEOPLE, ANIMALS

OR MACHINES IS NOT A PROBLEM. C. SYNTHETIC OR ORGANIC SOIL STABILIZERS MAY BE USED UNDER SUITABLE CONDITIONS AND IN OUANTITIES AS RECOMMENDED BY THE MANUFACTURER.

D. WOOD-FIBER OR PAPER-FIBER MULCH AT THE RATE OF 1.500 LBS,/ACRE OR ACCORDING TO THE MANUFACTURER'S REQUIREMENTS MAY BE APPLIED BY A HYDROSEEDER

E. MULCH NETTING, SUCH AS PAPER JUTE, EXCELSIOR, COTTON OR PLASTIC MAY BE USED. F. WOOD CHIPS APPLIED UNIFORMLY TO A MINIMUM DEPTH OF 2" MAY BE USED. WOOD CHIPS SHALL NOT BE USED ON AREAS WHERE FLOWING WATER CAN WASH THEM INTO AN INLET AND CLOG IT.

MULCH ANCHORING FOLLOWING METHODS DEPENDING UPON THE SIZE OF THE AREA AND SLOPE STEEPNESS A. PEG AND TWINE: DRIVE 8" TO 10" INCH WOODEN PEGS TO WITHIN 2" TO 3" INCHES OF THE SOIL SURFACE EVERY 4' FEET IN ALL DIRECTIONS. STAKES MAY BE DRIVEN BEFORE OR AFTER APPLYING MULCH. SECURE MULCH TO SOIL SURFACE BY STRETCHING TWINE BETWEEN PEGS IN A CRISSCROSS AND A SOUARE PATTERN. SECURE TWINE AROUND

EACH PEG WITH TWO OR MORE ROUND TURNS. B. MULCH NETTING: STAPLE PAPER, COTTON OR PLASTIC NETTING OVER MULCH. USE A DEGRADABLE NETTING IN AREAS TO BE MOWED. NETTING IS USUALLY AVAILABLE IN ROLLS 4' FEET WIDE AND UP TO 300' FEET LONG.

C. CRIMPER MULCH ANCHORING COULTER TOOL: A TRACTOR DRAWN IMPLEMENT ESPECIALLY DESIGNED TO PUNCH AND ANCHOR MULCH INTO THE SOIL SURFACE. THIS PRACTICE AFFORDS MAXIMUM EROSION CONTROL BUT ITS USE IS LIMITED TO THOSE SLOPES UPON WHICH THE TRACTOR CAN OPERATE SAFELY. SOIL PENETRATION SHOULD BE ABOUT 3" TO 4" INCHES. ON SLOPING LAND, THE OPERATION SHOULD BE ON THE CONTOUR.

 APPLICATIONS SHOULD BE HEAVIER AT EDGES WHERE WIND CATCHES THE MULCH, IN VALLEYS AND AT CRESTS OF BANKS. REMAINDER OF AREA SHOULD BE UNIFORM IN APPEARANCE.

 USE OF ONE OF THE FOLLOWING: -EMULSIFIED ASPHALT: (SS-1,CSS-1, MS-2, RS-1, RS-2, CRS-1 AND CRS-2) APPLY 0.04 GAL/SY OR 194 GAL./ACRE ON FLAT AREAS AND ON SLOPES LESS THAN 8' FEET OR MORE HIGH, USE 0.075 GAL./SY OR 363 GAL./ACRE. THESE MATERIALS MAY BE DIFFICULT TO APPLY UNIFORMLY AND WILL DISCOLOR SURFACES -ORGANIC AND VEGETABLE BASED BINDERS: NATURALLY OCCURRING, POWDER BASED, HYDROPHILIC MATERIALS THAT MIXED WITH WATER FORMULATES A GEL AND WHEN APPLIED TO MULCH UNDER SATISFACTORY CURING CONDITIONS WILL FORM MEMBRANE NETWORKS OF INSOLUBLE POLYMERS. THE VEGETABLE GEL SHALL BE PHYSIOLOGICALLY HARMLESS AND NOT RESULT IN A PHYTOTOXIC EFFECT OR IMPEDE GROWTH OF TURFGRASS VEGETABLE BASED GELS SHALL BE APPLIED AT RATES AND WEATHER CONDITIONS RECOMMENDED BY THE MANUFACTURER. -SYNTHETIC BINDERS: HIGH POLYMER SYNTHETIC EMULSION, MISCIBLE WITH WATER WHEN DILUTED AND FOLLOWING APPLICATION TO MULCH, DRYING AND CURING

SHALL NO LONGER BE SOLUBLE OR DISPERSIBLE IN WATER. IT SHALL BE APPLIED AT RATES AND WEATHER CONDITIONS RECOMMENDED BY THE MANUFACTURER AND

REMAIN TACKY UNTIL GERMINATION OF GRASS. ALL TOPSOIL STOCKPILES SHALL BE LOCATED AT LEAST 5 FEET AWAY FROM BUILDINGS.

SEQUENCE OF CONSTRUCTION:

INSTALL ALL SOIL EROSION & SEDIMENT CONTROL MEASURES INCLUSIVE OF SILT FENCE, STABILIZED CONSTRUCTION ENTRANCES, AND INLET FILTERS. (2 WEEKS)

PERFORM DEMOLITION IN ACCORDANCE WITH THE DEMOLITION PLAN. CLEAR AND ROUGH GRADE FOR BUILDING AND ALL OTHER STRUCTURES REQUIRING EXCAVATION. (1 MONTH)


ROUGH GRADE THE SITE FOR NEW ASPHALT. (1 MONTH) 4. EXCAVATE FOR BUILDING FOUNDATIONS, STORMWATER SYSTEMS, & OTHER FEATURES. (1 MONTH)

5. COMPLETE BUILDING CONSTRUCTION. (6-12 MONTHS)

5. PERFORM FINAL GRADING OF THE SITE. (1 MONTH) 7. CONDUCT SOIL COMPACTION TESTING AND REMEDIATE SUBSOIL (SCARIFICATION/TILLAGE TO A MINIMUM DEPTH OF 6") AS NECESSARY UNIFORMLY APPLY TOPSOIL TO AN AVERAGE DEPTH OF 5", MINIMUM OF

10. REMOVE ALL TEMPORARY SEDIMENT AND EROSION CONTROL

LEGEND PROPOSED CONSTRUCTION ENTRANCE PROPOSED SILT FENCE PROPOSED INLET FILTER PROPOSED LIMITS OF DISTURBANCE SOIL COMPACTION TESTING AREAS LIMIT OF SOIL COMPACTION TESTING RECOMMENDED SOIL COMPACTION **TESTING LOCATION**

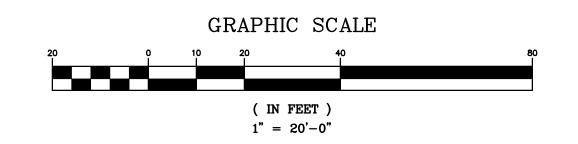



60 GRAND AVENUE ENGLEWOOD. NJ 07631 201.227.0300 • 201.227.0001 (Fax)

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New Jersey Professional Engineer #24GE04081200


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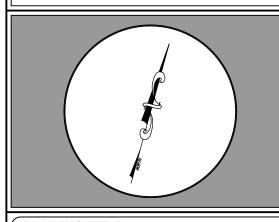
732.223.3520 (PHONE) SUR VEYOR:

MIDATLANTIC ENGINEERING PARTNERS, LLC **GATEWAY 195 CENTRE** 5 COMMERCE WAY, SUITE 200 HAMILTON, NJ 08691 609.910.4450 (PHONE)

ARCHITECT: STUDIO 200 ARCHITECTURE, LLC. 200 UNION AVENUE BRIELLE, NJ 08730 732.528.2240 (PHONE)




PROPOSED MULTI-FAMILY BUILDING 2613-2615 ROUTE 88 BOROUGH OF POINT PLEASANT OCEAN COUNTY, NJ BLOCK 45, LOT 1, TAX MAP 7

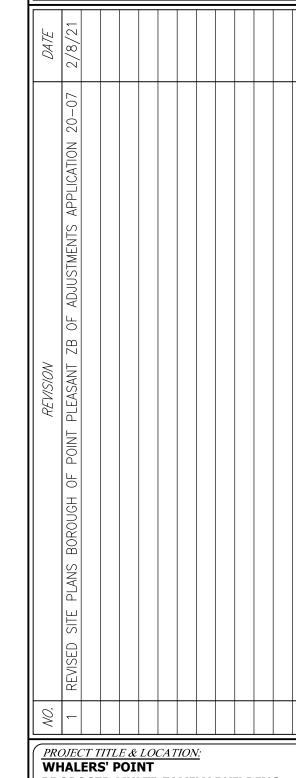

DRAWING TITLE: **SOIL EROSION &** SEDIMENT CONTROL **PLAN**


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TYPICAL STOCKPILE SECTION

EXISTING GRADE-

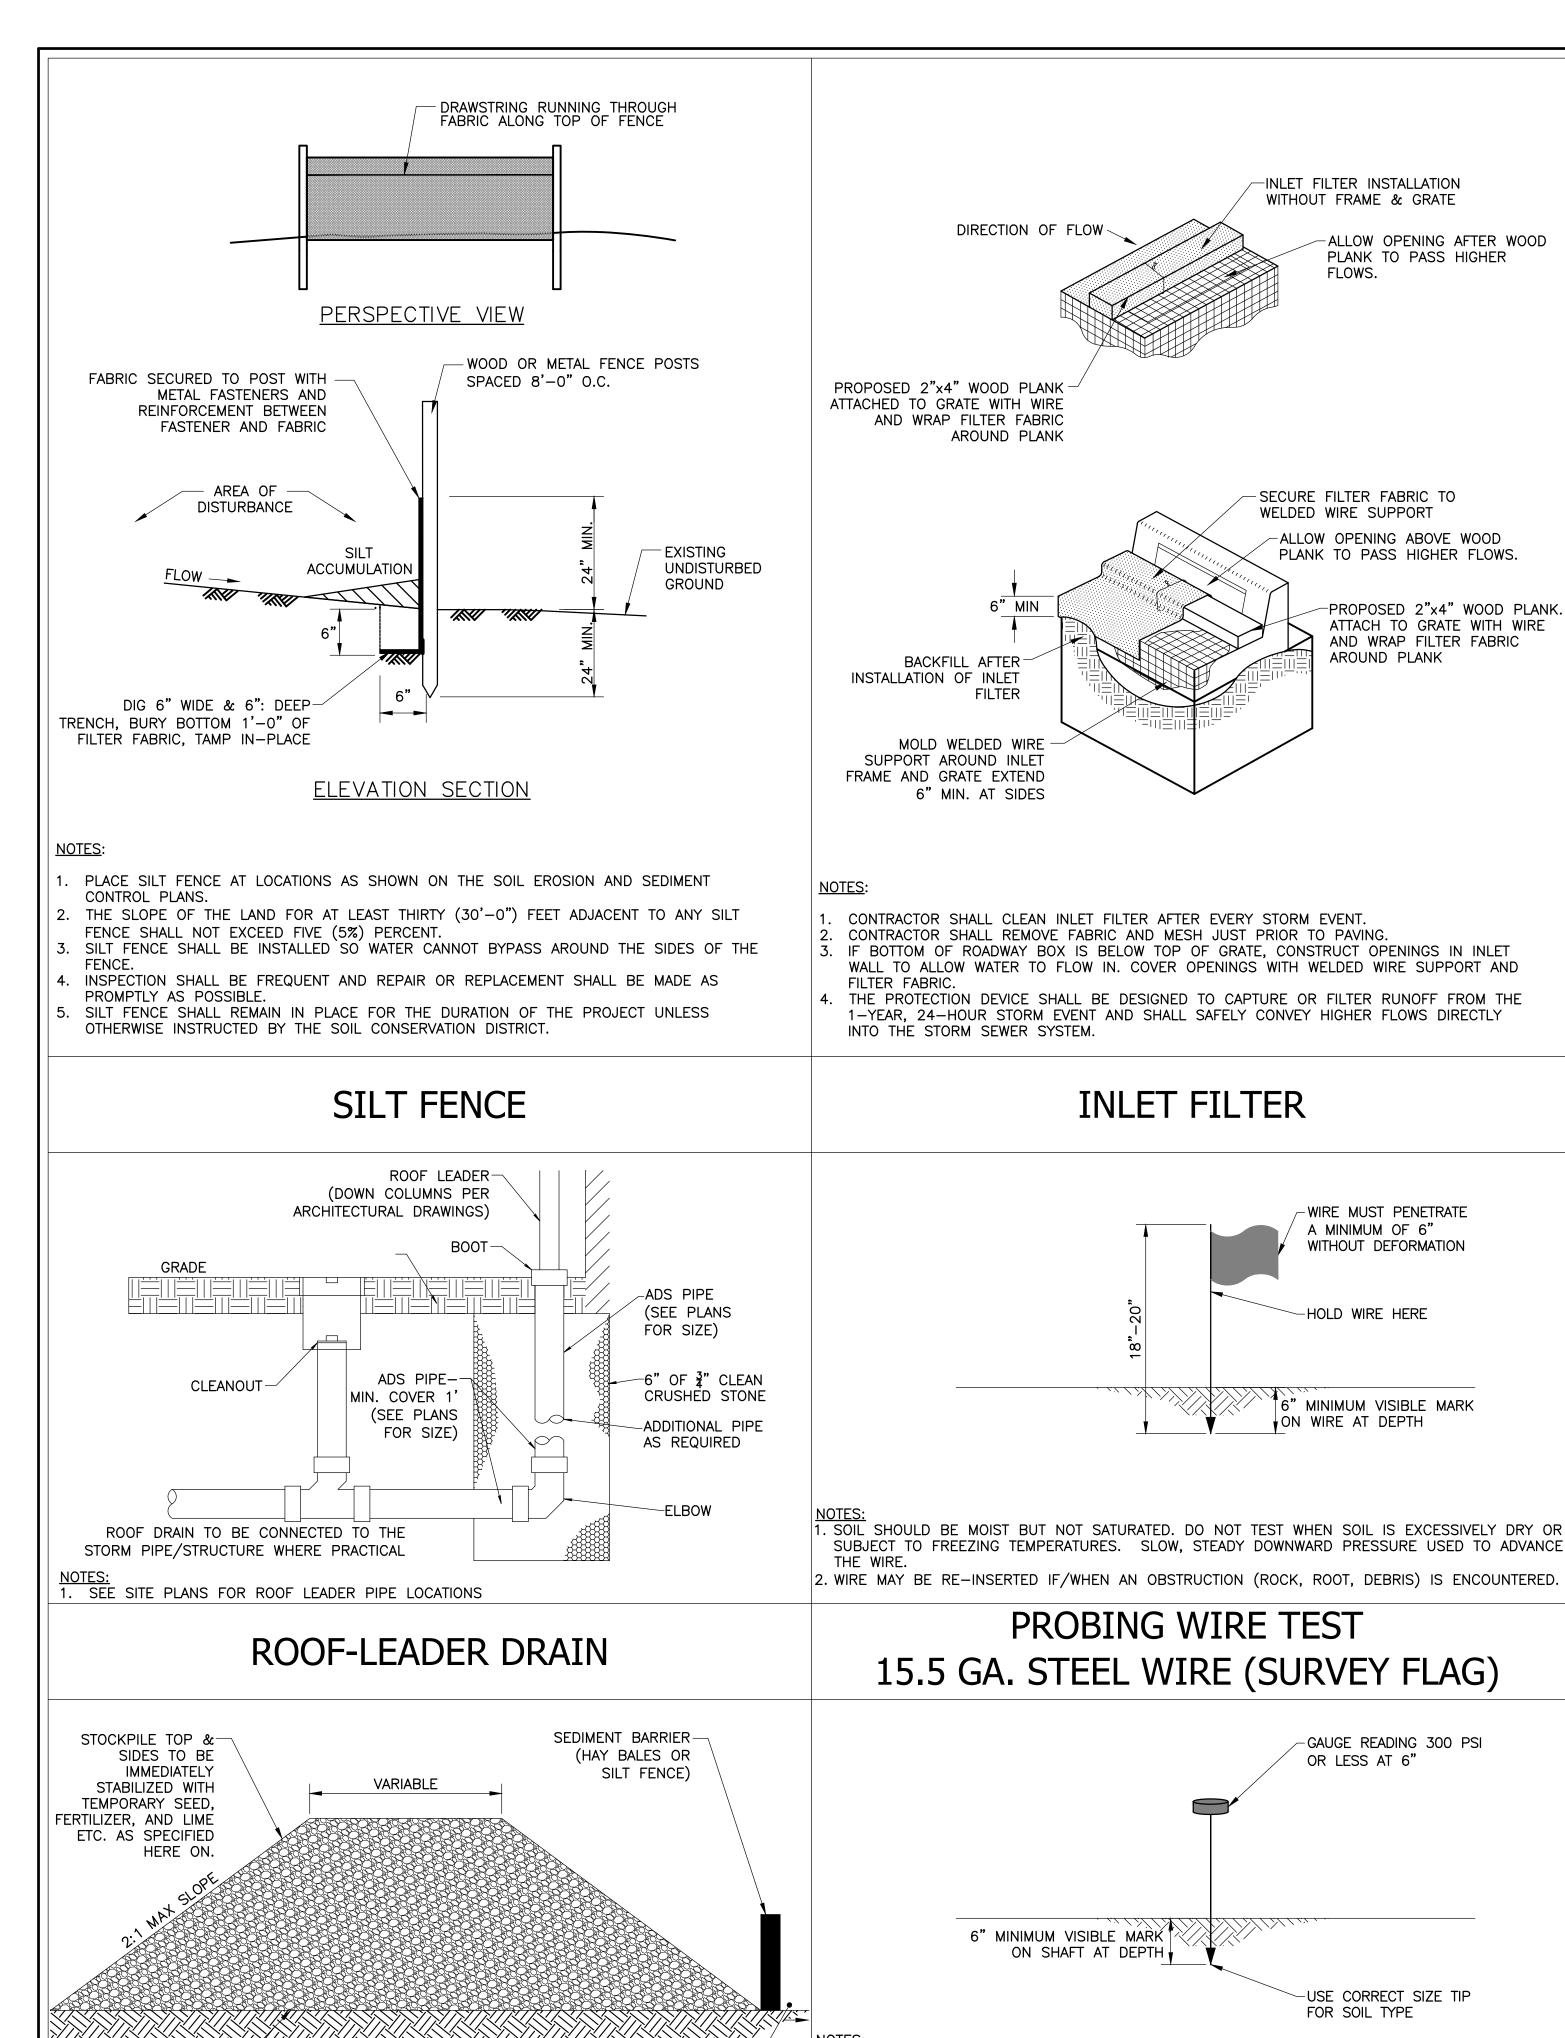

- CLOTH TO BE PLACED OVER THE ENTIRE AREA PRIOR TO PLACING OF STONE LENGTH - 50 FEET MINIMUM WHERE THE SOILS ARE COURSE-GRAINED (SAND OR GRAVELS) OR 100 FEET MINIMUM WHERE SOILS ARE FINE-GRAINED (CLAYS OF SILTS), EXCEPT WHERE
- THE TRAVELED LENGTH IS LESWS THAN 50 OR 100 FEET RESPECTIVELY. (SEE TABLE B) SURFACE WATER — ALL SURFACE WATER FLOWING OR DIVERTED TOWARD CONSTRUCTION ENTRANCES SHALL BE PIPED ACROSS THE ENTRANCE. IF PIPING IS IMPRACTICAL, A MOUNTABLE BERM WITH 5:1 SLOPES WILL BE PERMITTED
- MAINTENANCE THE ENTRANCE SHALL BE MAINTAINED IN A CONDITION WHICH WILL PREVENT TRACKING OF FLOWING OF SEDIMENT ONTO PUBLIC RIGHTS-OF-WAY. THIS MAY REQUIRE PERIODIC TOP DRESSING WITH ADDITIONAL STONE AS CONDITIONS DEMAND AND REPAIR AND/OR CLEANOUT OF ANY MEASURE USED TO TRAP SEDIMENT. ALL SEDIMENT SPILLED, DROPPED, WASHED OR TRACKED ONTO PUBLIC RIGHTS-OF-WAY SHALL BE REMOVED WASHING - WHEELS SHALL BE CLEANED TO REMOVE SEDIMENT PRIOR TO ENTRANCE ONTO
- STABILIZED WITH STONE AND WHICH DRAINS INTO AN APPROVED SEDIMENT TRAPPING DEVICE. PERIODIC INSPECTION AND NEEDED MAINTENANCE SHALL BE PROVIDED AFTER EACH RAIN WHERE THE SLOPE OF THE ACCESS ROAD EXCEEDS 5%, A STABILIZED LOOSE COURSE OF FINE FINE AGGREGATE BITUMINOUS CONCRETE (FABC) SHALL BE INSTALLED. THE TYPE AND

PERSCRIBED BY LOCAL MUNICIPAL ORDINANCE OR GOVERNING AUTHORITY

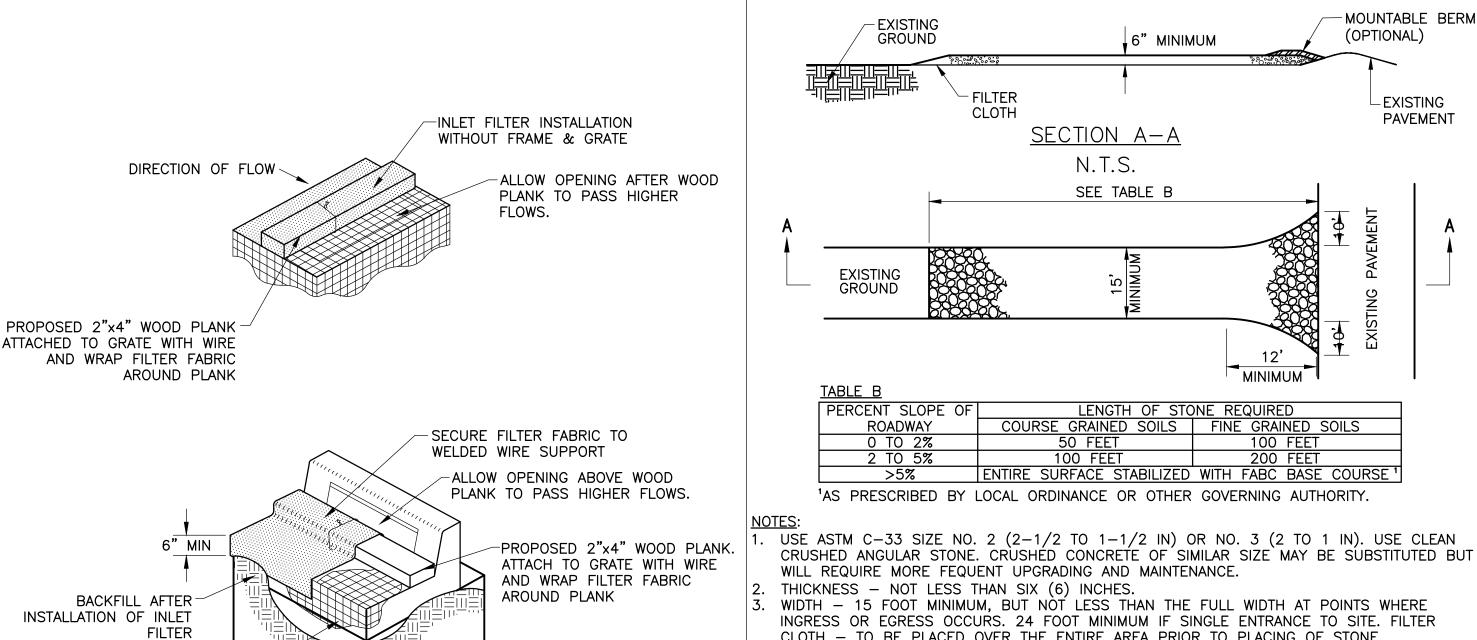~½" WIRE MESH -GEOTEXTTILE

PERFORATE 60" CMP WITH 1" HOLES AT 6" ON CENTER.

SECTIONS

72" CMP-

60" CMP-


PUBLIC RIGHTS-OF-WAY. WHEN WASHING IS REQUIRED, IT SHALL BE DONE ON AN AREA

2 - 2" x 2" STAKES DRIVEN 1-1/2' TO 2' INTO THE GROUND. SEE NOTE No. 6 -RETAIN EXISTING VEGETATION (WHERE PRESENT) ELEVATION VIEW FLOW $2 - 2" \times 2" \times 3'$ STAKES PER BALE PLAN VIEW

- THE BALES SHALL BE PLACED IN A ROW WITH ENDS TIGHTLY ABUTTING THE BALES. 2. EACH BALE SHALL BE INSTALLED IN THE SOIL A MINIMUM OF 4", AND SHALL BE PLACED
- SO THAT THE BALE BINDINGS ARE HORIZONTAL AS SHOWN ON THE DETAIL. 3. THE HAY BALES SHALL BE SECURELY ANCHORED IN PLACE WITH TWO STAKES OR RE-BARS DRIVEN THROUGH THE BALES. THE FIRST STAKE IN EACH BALE SHALL BE DRIVEN TOWARDS THE PREVIOUSLY LAID BALE AT AN ANGLE TO FORCE THE BALES TOGETHER. THE STAKES SHALL BE DRIVEN FLUSH WITH THE TOP OF THE BALE. 4. INSPECTION OF THE BALES SHALL BE DONE FREQUENTLY BY THE CONTRACTOR AND ALL
- REPAIR OR REPLACEMENT OF THE BALES SHALL BE DONE IMMEDIATELY. 5. THE HAY BALES SHALL BE REMOVED AND REPLACED WHEN THEY HAVE DETERIORATED
- BEYOND THEIR USEFULNESS SO AS NOT TO BLOCK OR IMPEDE STORM DRAINAGE FLOW. 6. IF THE STRAW BALES ARE WIRE BOUND, THEY SHOULD BE ORIENTED SO THE BINDINGS ARE AROUND THE SIDES RATHER THAN THE BOTTOM OF THE BALES. WIRE BINDINGS THAT ARE PLACED IN CONTACT WITH THE SOIL SOON DISINTEGRATE, AND MAY ALLOW THE BALES TO FALL APART.

STABILIZED CONSTRUCTION ENTRANCE

THICKNESS OF THE FABC AND USE OF A COURSE GRADED AGGREGATE SUB-BASE SHALL BE

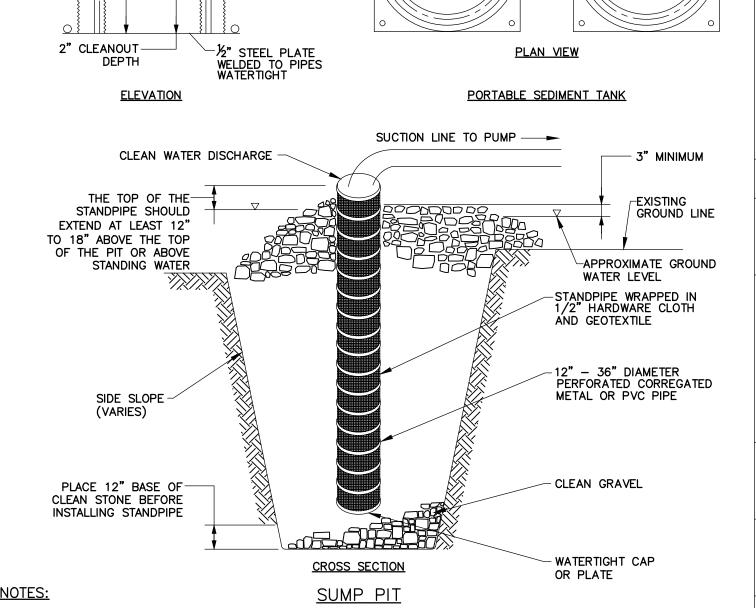

1					<u> </u>	וועול וועול						
1.	 DIMENSIONS	ARE	VARIABLE	WITH	THE	MINIMUM	DIAMETER	BEING	2	TIMES	THE	STANDPIPE

THE STANDPIPE SHOULD BE CONSTRUCTED BY PERFORATING A 12" TO 24" DIAMETER CORRUGATED OR PVC PIPE. THEN WRAPPING WITH 1/2" HARDWARE CLOTH AND GEOTEXTILE

FABRIC. THE PERFORATIONS SHALL BE 1/2" x 6" SLITS OR 1" DIAMETER HOLES. A BASE OF FILTER MATERIAL CONSISTING OF CLEAN GRAVEL OR ASTM C33 STONE SHOULD BE SHOULD BE MOIST BUT NOT SATURATED. DO NOT TEST WHEN SOIL IS EXCESSIVELY DRY OR PLACED IN THE PIT TO A DEPTH OF 12". AFTER INSTALLING THE STANDPIPE, THE PIT SUBJECT TO FREEZING TEMPERATURES. SLOW, STEADY DOWNWARD PRESSURE USED TO ADVANCE SURROUNDING THE STANDPIPE SHOULD THEN BE BACKFILLED WITH THE SAME FILTER MATERIAL THE STANDPIPE SHOULD EXTEND 12" TO 18" ABOVE THE LIP OF THE PIT OR THE RISER CREST ELEVATION (BASIN DEWATERING ONLY) AND THE FILTER MATERIAL SHOULD EXTEND 3" MINIMUM ABOVE THE ANTICIPATED STANDING WATER ELEVATION.

DIRECTIONAL SIGNAGE TABLE

HAY BALE PROTECTION

DESIGNATION No.	SIGN CONTENT	NJDOT STANDARD No.	SIZE	COLOR	MOUNTING TYPE
	STOP	R1-1	30"X30"	RED BACKGROUND WHITE CHARACTERS	POLE MOUNTED GROUND MOUNTED
2	RESERVED PARKING	R7-8	12"x18"	WHITE BACKGROUND BLUE AND BLACK CHARACTERS	POLE MOUNTED GROUND MOUNTED
	ACCESSIBLE ACCESSIBLE	R7-8a	12"x6"		
	\$250, SING OFFENSE \$250, SING OFFENSE \$250, SING OFFENSE \$P\$ 10 50 MISS \$P\$ 10 50	R7-8a (MOD)	18"x18"		
3	DO NOT ENTER	R5-1	30"x30"	RED BACKGROUND WHITE CHARACTERS	POLE MOUNTED
4	ONE WAY	R6-1 LEFT	36"X12"	WHITE ARROW BLACK BACKGROUND & CHARACTERS	POLE MOUNTED

PROJECT TITLE & LOCATION: WHALERS' POINT PROPOSED MULTI-FAMILY BUILDING 2613-2615 ROUTE 88 BOROUGH OF POINT PLEASANT OCEAN COUNTY, NJ BLOCK 45, LOT 1, TAX MAP 7

ENGLEWOOD. NJ 07631

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DETAILS - 1

DRAWING TITLE

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C-09

HANDHELD SOIL PENETROMETER TEST

THE PROBE. PROBE MUST PENETRATE AT LEASE 6" WITH LESS THAN 300 PSI READING ON THE

2. PENETROMETER MAY BE RE-INSERTED IF/WHEN AN OBSTRUCTION (ROCK, ROOT, DEBRIS) IS

6" MINIMUM VISIBLE MARK

SLOPE-

GUAGE.

ON SHAFT AT DEPTH

INLET FILTER

PROBING WIRE TEST

WIRE MUST PENETRATE A MINIMUM OF 6" WITHOUT DEFORMATION

6" MINIMUM VISIBLE MARK

GAUGE READING 300 PSI

-USE CORRECT SIZE TIP

OR LESS AT 6"

ON WIRE AT DEPTH

DEWATERING

